
INDEX OF SHEETS SEE SHEET 2

# A COMMARYLAND DEPARTMENT OF TRANSPORTATION

## STATE HIGHWAY ADMINISTRATION

S.H.A. CONTRACT NO. - QA2985177 FEDERAL AID PROJECT NO. - AC-STBG-G-295-1(10)E MD 213 (LIBERTY STREET AND COMMERCE STREET) FROM MILL STREAM BRANCH TO GRAVEL RUN SAFETY AND RESURFACING

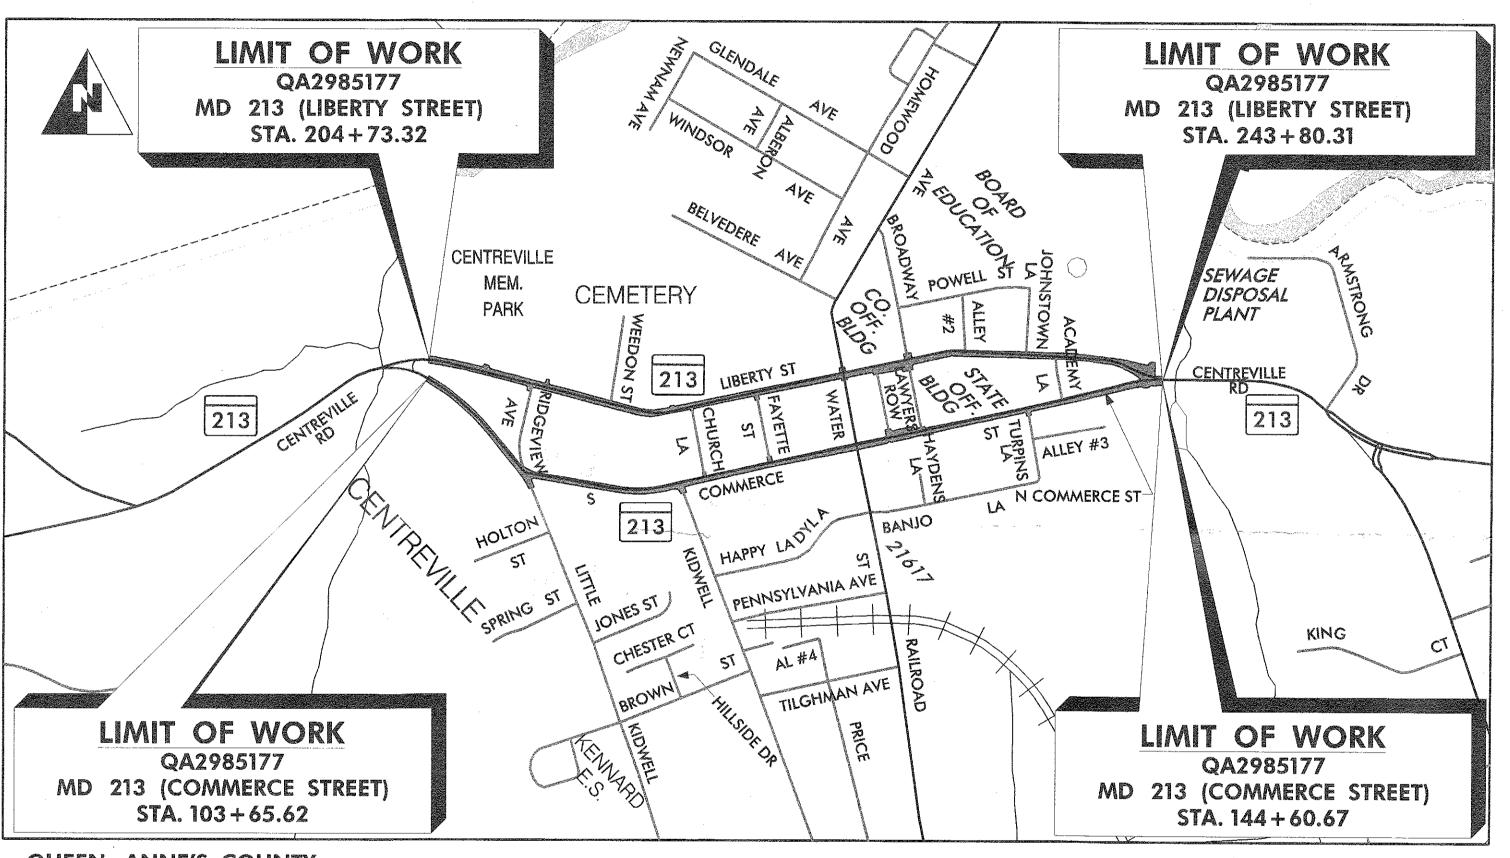

## QUEEN ANNE'S COUNTY

HORIZONTAL DATUM NAD 83 /91 VERTICAL DATUM | NAVD 88

LENGTH OF PROJECT: MD 213 (LIBERTY STREET) = 0.74 MILES MD 213 (COMMERCE STREET) = 0.78 MILES

DESIGN DE	SIGNATION		SURVEY BOOK NUMBERS	RIGHT OF WAY PLAT NUMBERS	<b>REVISIONS</b> NOTE: SEE SHEET NO. 2 FOR LIST OF REVISED SHEET NUMBERS	
ROADWAY	MD 213 (COM)	MERCE STREET)		1093		
ROADWAY LENGTH (MILES)	0.	.78	_	1050		
CONTROLS YEARS	2015	2035		1156		ĺ
AVERAGE DAILY TRAFFIC (A.D.T.)	21,475	31,300	·			
DESIGN HOURLY VOLUME (D.H.V.)			·	1047		ĺ
DIRECTIONAL DISTRIBUTION			*	1141		ĺ
% TRUCKS (A.D.T.)	7%	7%	,	0833		ĺ
% TRUCKS (D.H.V.)	,		•	1115		
FUNCTIONAL CLASSIFICATION	MINOR A	RTERIAL	•	0707		İ
CONTROL OF ACCESS	NO	ONE	•	0916		<u> </u>
INTENSITY OF DEVELOPMENT	RU	RAL	•	0849		
TERRAIN	ROL	LING	•			ļ
DESIGN SPEED (M. P. H.)	35 1	MPH	y			
ANTICIPATED POSTED SPEED (M. P. H.)	251	MPH	•			i
, ,	t .	t t		, 1		

GEOMETRIC DESIGN CRITERIA

THIS PROJECT WAS DESIGNED IN ACCORDANCE WITH THE 2011 PUBLICATION OF AMERICAN ASSOCIATION OF STATE HIGHWAY AND TRANSPORTATION OFFICIALS (AASHTO) "A POLICY ON GEOMETRIC DESIGN OF HIGHWAYS AND STREETS"

STANDARD SPECIFICATIONS BOOK, BOOK OF STANDARDS AND MANUAL ON UNIFORM TRAFFIC CONTROL DEVICES (MUTCD)

ALL WORK ON THIS PROJECT SHALL CONFORM TO: THE LATEST APPROVED MARYLAND DEPARTMENT OF TRANSPORTATION STATE HIGHWAY ADMINISTRATION (MDOT SHA) "STANDARD SPECIFICATIONS FOR CONSTRUCTION AND MATERIALS" REVISIONS THEREOF OR ADDITIONS THERETO, AS INDICATED IN THE PROJECT DESCRIPTION OF THE INVITATION FOR BIDS BOOK; THE SPECIAL PROVISIONS INCLUDED IN THE INVITATION FOR BIDS BOOK; THE ADMINISTRATION'S "BOOK OF STANDARDS FOR HIGHWAYS AND INCIDENTAL STRUCTURES" AND THE LATEST ADOPTED MUTCH.

#### RIGHT OF WAY

RIGHT OF WAY AND EASEMENT LINES SHOWN ON THESE PLANS ARE FOR ASSISTANCE IN INTERPRETING THE PLANS. THEY ARE NOT OFFICIAL. FOR OFFICIAL FEE RIGHT OF WAY AND EASEMENT INFORMATION, SEE APPROPRIATE

THE LOCATION OF UTILITIES SHOWN ON THE PLANS ARE FOR INFORMATION AND GUIDANCE ONLY. NO GUARANTEE IS MADE OF THE ACCURACY OF SAID LOCATIONS.

#### ADA COMPLIANCE

THE DESIGN OF THIS PROJECT HAS INCORPORATED FACILITIES TO ACCOMMODATE PERSONS WITH DISABILITIES IN COMPLIANCE WITH STATE AND FEDERAL REQUIREMENTS.

#### **ENVIRONMENTAL INFORMATION**

ALL STORMWATER MANAGEMENT FACILITIES CONSTRUCTED FOR THIS CONTRACT SHALL BE INSPECTED AND MAINTAINED IN ACCORDANCE WITH THE MOOT SHA BEST MANAGEMENT PRACTICES (BMP) INSPECTION AND REMEDIATION PROGRAM

#### STANDARD STABILIZATION NOTE:

FOLLOWING INITIAL SOIL DISTURBANCE OR REDISTURBANCE, PERMANENT OR TEMPORARY STABILIZATION SHALL BE COMPLETED WITHIN THREE (3) CALENDAR DAYS AS TO THE SURFACE OF ALL PERIMETER CONTROLS, DIKES, SWALES, DITCHES, PERIMETER SLOPES, AND ALL SLOPES GREATER THAN 3 HORIZONTAL TO 1 VERTICAL (3:1), AND SEVEN DAYS (7) AS TO ALL OTHER DISTURBED OR GRADED AREAS ON THE PROJECT SITE.

STORMWATER AND SEDIMENT CONTROL FINAL APPROVAL

#### **OWNERS / DEVELOPERS CERTIFICATION:**

I / WE HEREBY CERTIFY THAT ANY CLEARING, GRADING, CONSTRUCTION AND/OR DEVELOPMENT WILL BE DONE PURSUANT TO THIS PLAN, AND THAT ANY RESPONSIBLE PERSONNEL INVOLVED IN THE CONSTRUCTION PROJECT WILL HAVE A CERTIFICATE OF ATTENDANCE AT A MARYLAND DEPARTMENT OF THE ENVIRONMENT (MDE) APPROVED TRAINING PROGRAM FOR THE CONTROL OF SEDIMENT AND EROSION BEFORE BEGINNING THE PROJECT. I HEREBY AUTHORIZE THE RIGHT OF ENTRY FOR PERIODIC ON-SITE EVALUATION BY MDE COMPLIANCE INSPECTORS.

APPROVED DATE DIVISION CHIEF, PLAN REVIEW DIVISION EXEMPT EXPIRATION DATE: DISTRICT ENGINEER, DISTRICT memaialu DIRECTOR, OFFICE OF HIGHWAY DEVELOPMENT DEPUTY ADMINISTRATOR / CHIEF ENGINEER FOR PLANNING, ENGINEERING, REAL ESTATE AND ENVIRONMENT STRUCTURE INVENTORY NO. CONTRACT NO.: QA2985177

**MODIFICATIONS** 

MD LICENSE NO. 44092 EXPIRATION DATE: 06-10-2021 \\baserver1\Projects\5871\_MD\_MDSHA\_SurveyEng\07\_On-site Support for Fund 77\300\_CADD\Plan\_Set\Roadway\MD 213\pGN-T001\_MD 213.dgn Wednesday, December 04, 2019 AT 01:54 PM

MD LICENSE NO. 25381 EXPIRATION DATE: 07-19-2020 **MERCADO** 29, EROSION AND SEDIMENT CONTROL HEREBY CERTIFY THAT THESE DOCUMENTS WERE PREPARED OR APPROVED BY ME, AND THAT I AM A DULY LICENSED PROFESSIONAL ENGINEER UNDER THE LAWS OF THE STATE OF MARYLAND. MD LICENSE NO. 38630 EXPIRATION DATE: 04-08-2020 McCORMICK TAYLOR I HEREBY CERTIFY THAT THESE DOCUMENTS WERE PREPARED OR APPROVED BY ME, AND THAT I AM A DULY LICENSED PROFESSIONAL ENGINEER UNDER THE LAWS OF THE STATE OF MARYLAND.

McCORMICK TAYLOR

I HEREBY CERTIFY THAT THESE DOCUMENTS WERE PREPARED OR APPROVED BY

ME, AND THAT I AM A DULY LICENSED PROFESSIONAL ENGINEER UNDER THE

30, MAINTENANCE OF TRAFFIC NOTES

LAWS OF THE STATE OF MARYLAND.

## INDEX OF SHEETS

SHEET NO.	DWG. NO.	
1	_	TITLE SHEET
2	GI-01	INDEX OF SHEETS
3	GN-01	ABBREVIATIONS / GENERAL NOTES SHEET
4–5	TS-01 TO TS-02	TYPICAL SECTIONS SHEETS
6	DE-01	DETAIL SHEET
7	GS-01	GEOMETRIC LAYOUT SHEETS
8	RC-01	RAMP CONSTRUCTION DETAIL SHEET
9	SL-01	SITE LAYOUT SHEET
10–28	PS-01 TO PS-19	ROADWAY PLAN SHEETS
29	ES-01	EROSION AND SEDIMENT CONTROL NOTES
30	MT-01	MAINTENANCE OF TRAFFIC GENERAL NOTES SHEET



DISTRICT 2
PROJECT DEVELOPMENT
MD 213 (LIBERTY STREET AND
COMMERCE STREET)
FROM MILL STREAM BRANCH
TO GRAVEL RUN
SAFETY AND RESURFACING

R /W PLAT NUMBER	CROSS REFERENCE	REVISIONS	INDEX OF SHEETS
	ITEM SHEET NOs.  INDEX OF SHEETS 2		SCALE AS SHOWN ADVERTISED DATE DEC 2019 CONTRACT NO. QA2985177
	GENERAL NOTES SHEET       3         TYPICAL SECTIONS       4–5         DETAIL SHEET       6         GEOMETRIC LAYOUT SHEET       7         RAMP CONSTRUCTION DETAIL       8         SITE LAYOUT SHEET       9         ROADWAY PLANS       10–28         EROSION AND SEDIMENT CONTROL NOTES       29		DESIGNED BY DPK COUNTY QUEEN ANNE'S  DRAWN BY PNK LOGMILE 7.06 - 7.85  CHECKED BY GGW HORIZONTAL SCALE N/A  MDE/PRD EXEMPT VERTICAL SCALE N/A
	MAINTENANCE OF TRAFFIC NOTES		DRAWING NO. GI-01 OF GI-01 SHEET NO. 2 OF 30

McCORMICK TAYLOR

509 South Exeter Street
4th Floor
Baltimore, Maryland 21202

(410) 662-7400

PLOTTED: Monday, December 09, 2019 AT 01:42 PM
FILE: \\baserver1\Projects\5871\_MD\_MDSHA\_SurveyEng\07\_On-site Support for Fund 77\300\_CADD\Plan\_Set\Roadway\MD 213\pGN-I001\_MD 213.dgn


## ABBREVIATIONS

AASHTO	American Association of State Highway	HDWL.
	Transportation Officials	HERCP.
ADT	Average Daily Traffic	
AHD	Ahead	HP
APPROX	. Approximate	IN
₽ or B/L	Baseline	I.S.T
BK	.Back /Book	INV
BIT	. Bituminous	J.B
B.C	. Bituminous Concrete	K
B.M	Bench Mark	L
BOT	. Bottom	LF
C.C	Center of Curve	L.L
CAP	. Corrugated Aluminum Pipe	LP
CAPA	Corrugated Aluminum Pipe Arch	L.P
CATV	Cable Television	LT
C.B.R	California Bearing Ratio	MAC
€ or C/L		M.C
CL		MAX.
CLF	Chainlink Fence	M.D.D.
	Corrugated Metal Pipe	MOD
C.O	•	MIN
COMB		N
CONC.		NB
CONSTR		NE
COR.		N.P
CORR.		O.C
	Corrugated Polyethylene Pipe – Type 'S'	O.M
	Corrugated Steel Pipe - Aluminized Type 2	O.P.A
	Corrugated Steel Pipe Arch -	OHE .
00171	Aluminized Type 2	PAV'T.
DC	Degree of Curve	PC .
	Design Hourly Volume	PCC .
D.I		P/C
DIA	•	P/GE
	Double Opening	P.G.E.
E		P.G.L.
E		P/GL
	External Distance	P/R
EA		P.I
EB		Pl
ELEV		POC
ES		POT
EX or EXIST.	<u> </u>	PPWP . PROP .
F or FL		
		PRC .
	Flat Bottom Ditch	PT
F.H		PT
FWD		PVC .
G		PVC
G.V		PVI
H.B		PVRC .
UDLE	High Density Polyetheylene	PVT
		R
		R.F
		RT

	l lee durall
HDWL	
HERCP	Horizontal Ellipitical Reinforced
	Concrete Pipe
	High Point
IN	
	Inlet Sediment Trap
INV	Invert
	Junction Box
K	K Inlet
L	Length
LF	Linear Feet
L.L	Liquid Limit
	Low Point
L.P	Light Pole
LT	
MAC	Macadam
	Major Collector
MAX	
	Maximum Dry Content
MOD.	
MIN	
N	
	Northbound
NE	
	Non–Plastic
	On Center
	Optimum Moisture
	Other Prinicpal Arterial
	Overhead Electric
PAV' T	
	Point of Curvature
	Point of Compound Curvature
	Point of Crown
P/GE	Profile Grade Elevation
P.G.E	Profile Ground Elevation
P.G.L	Profile Grade Line
P/GL	Profile Ground Line
P/R	Point of Rotation
P.I	Plasticity Index
PI	Point of Intersection
POC	Point On Curve
POT	Point On Tangent
	Polyvinyl Chloride Profile Wall Pipe
PROP	
	Point of Reverse Curve
PT	
	Point of Tangency
	Point of Vertical Curve
	Polyvinyl Chloride
	Point of Vertical Intersection
	Point of Vertical Intersection
	Point of Vertical Tangency
R	
	Rock Fragments
RT	nigni

	Right of Way
RCP	Reinforced Concrete Pipe
RCPP	Reinforced Concrete Pressure Pipe
	Rock Quality Designation
R.M	
S	
	Sanitary Sewer
	Southbound
S.D	Storm Drain
S.D.D	Surface Drain Ditch
S⁄E	Super Elevation
	Silt Fence
	Square Feet
SHT	
	Structural Steel Plate Pipe
	Structural Steel Plate Pipe Arch
	Standard Penetration Testing
SRP	Steel Spiral Rib Pipe -
	Aluminized Type 2
SRPA	Steel Spiral Rib Pipe Arch -
	Aluminized Type 2
SSD	Stopping Sight Distance
	Super Silt Fence
	Standard
STA	
	Single Opening
	Square Yards
SWM	Stormwater Management
T	Tangent
T	Telephone
	Top of Cover
T.G	Top of Grate
	Traverse Line
	Top of Manhole
TRAV	
	Temporary Swale
	Top of Slab
T.S	
TYP	
U.D	Under Drain
U.G	Underground
U.P	Utility Pole
USDA	United States Department
	of Agriculture
VCL	Vertical Clearance
	Vertical Curve Length
W	_
W	
	Westbound
	Wetland Buffer
	Water Meter
W.S	Wrapped Steel
WUS	Waters of the United States
W.V	Water Valve

## CONVENTIONAL SIGNS

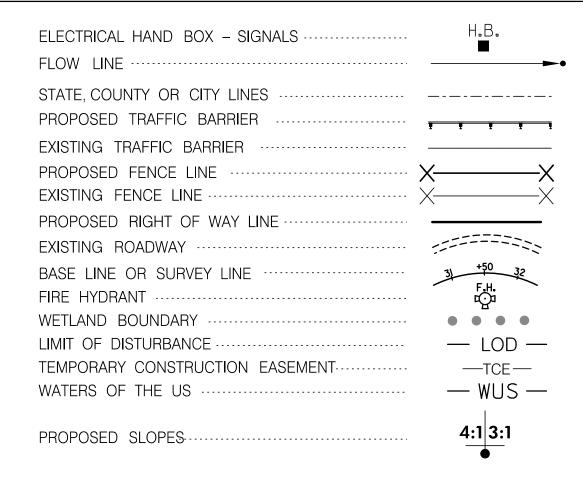

PROPOSED PIPE / CULVERT	
EXISTING PIPE / CULVERT ·····	⊫=======
EXISTING DROP INLET	<u> </u>
UTILITY POLE	-0-
WETLAND BUFFER ·····	
WATERS OF THE U.S.	√ WUS
HEDGE /TREE LINE ······	~~~~~
BUSH /TREE ·····	$\bigcirc$
CONIFEROUS TREE	W
COMI ENOUS THEE	3.6
GROUND ELEVATION	DATUM LINE -
GRADE ELEVATION	DATUM LINE   SO   SO   SO   SO   SO   SO   SO   S
SANITARY	- — — SAN — — —
WATER ·····	
GAS	
ELECTRIC (UNDERGROUND) ······	E
ELECTRIC (SHA) ······	— — E (SHA) —
TELEPHONE (UNDERGROUND)·····	T
EXISTING RIGHT OF WAY	
PROPOSED RIGHT OF WAY	
PROPOSED SEWER LINE	•••••
PROPOSED WATER LINE	
PROPOSED DOIT LINE	
PROPOSED GAS LINE	
ABANDONED WATER LINE	
ABANDONED SEWER LINE	-/ / SAN -

## GENERAL NOTES

- THE LOCATION OF THE UNDERGROUND AND SURFACE UTILITIES SHOWN ON THE PLANS ARE FOR INFORMATION AND GUIDANCE ONLY. NO GUARANTEE IS MADE AS TO THE ACCURACY OF SAID LOCATIONS. CONTRACTOR SHALL CONTACT "MISS UTILITY" AT 1-800-257-7777, 48 HOURS PRIOR TO EXCAVATION FOR MARKING AND LOCATION OF UTILITIES.
- 2. THE CONTRACTOR SHALL CHECK ALL DIMENSIONS AND ELEVATIONS PRIOR TO CONSTRUCTION. ANY CONFLICTS CONCERNING THE CONSTRUCTION AROUND EXISTING OBSTRUCTIONS PER THESE PLANS SHALL BE RESOLVED BETWEEN THE CONTRACTOR AND THE FIELD ENGINEER.
- 3. THE CONTRACTOR AND OTHERS SHALL PERFORM ALL WORK IN A PRACTICAL MANNER THAT WILL MINIMIZE OBSTRUCTION TO TRAFFIC, PEDESTRIANS, BUSINESSES, RESIDENTS, AND BE CONSISTENT WITH SAFETY.
- 4. ALL BENCHMARKS AND COORDINATES SHOWN ON THE CONTRACT PLANS ARE "NAD 83/91" AND A PROJECT SPECIFIC SURVEY DATUM.
- 5. ALL EXISTING UTILITY FRAMES, AND GRATES WITHIN THE LIMITS OF CONSTRUCTION SHALL BE ADJUSTED TO FINISHED GRADE.
- 6. THE CONTRACTOR WILL NOTIFY PROPERTY OWNERS 72 HOURS PRIOR TO RECONSTRUCTION OF DRIVEWAY ENTRANCES.
- 7. ALL TRANSITION SIDEWALK PANELS MUST BE CONSTRUCTED 5' MINIMUM OR TO THE NEXT EXISTING JOINT OR AS DIRECTED BY THE ENGINEER.
- 8. FOR DETECTABLE WARNING SURFACES REFER TO MDOT SHA STANDARD 655.40 FOR INSTALLATION.
- 9. PROPOSED CURB HEIGHTS SHOULD MATCH THE EXISTING CURB HEIGHTS AT THE TIE-IN POINTS




DISTRICT 2
PROJECT DEVELOPMENT
MD 213 (LIBERTY STREET AND
COMMERCE STREET)
FROM MILL STREAM BRANCH
TO GRAVEL RUN
SAFETY AND RESURFACING


R /W PLAT NUMBER	CROSS REFERENCE	REVISIONS	ABBREVIATIONS / GENERAL NOTES
	ITEM SHEET NOs.  INDEX OF SHEETS 2		SCALE N.T.S. ADVERTISED DATE <u>DEC 2019</u> CONTRACT NO. <u>QA2985177</u>
	GENERAL NOTES SHEET       3         TYPICAL SECTIONS       4-5         DETAIL SHEET       6         GEOMETRIC LAYOUT SHEET       7         RAMP CONSTRUCTION DETAIL       8         SITE LAYOUT SHEET       9         ROADWAY PLANS       10-28         EROSION AND SEDIMENT CONTROL NOTES       29         MAINTENANCE OF TRAFFIC NOTES       30		DESIGNED BY DPK COUNTY QUEEN ANNE'S  DRAWN BY PNK LOGMILE 7.06 - 7.85  CHECKED BY GGW HORIZONTAL SCALE N/A  MDE/PRD EXEMPT VERTICAL SCALE N/A
			DRAWING NO. GN-01 OF GN-01 SHEET NO. 3 OF 30




509 South Exeter Street 4th Floor Baltimore, Maryland 21202 (410) 662-7400

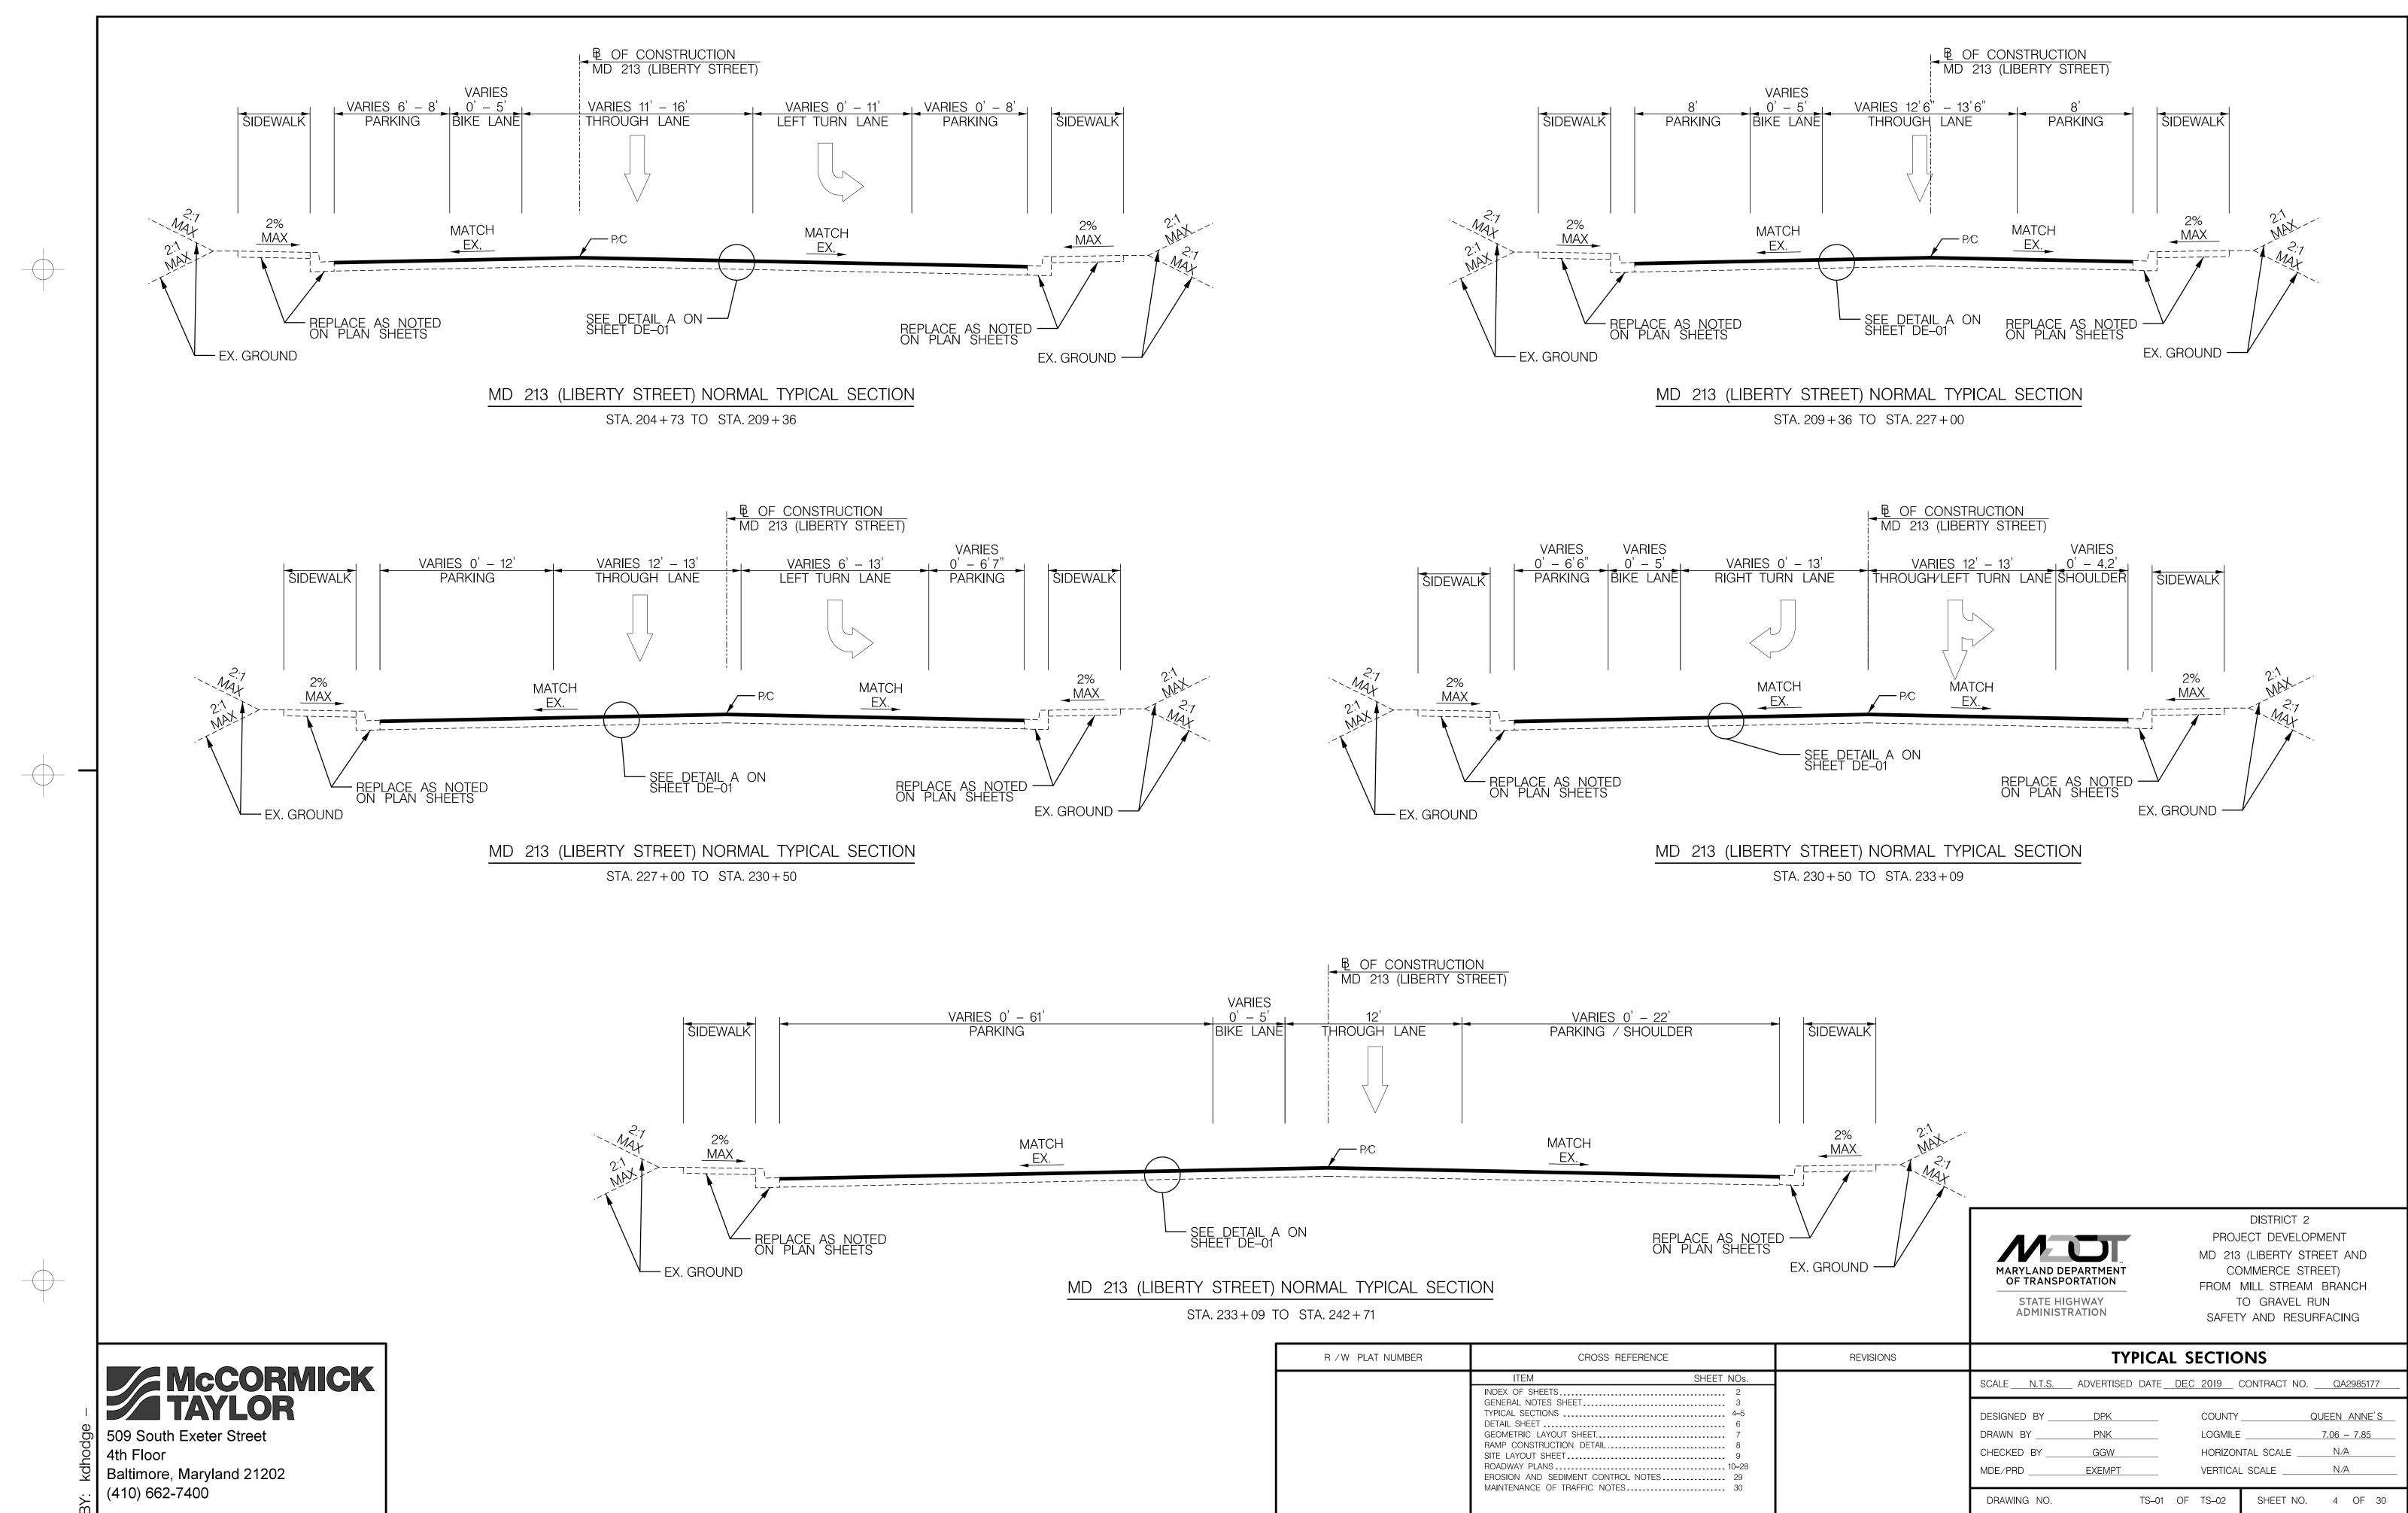

PLOTTED: Monday, December 09, 2019 AT 01:42 PM
FILE: \\baserver1\Projects\5871\_MD\_MDSHA\_SurveyEng\07\_On-site Support for Fund 77\300\_CADD\Plan\_Set\Roadway\MD 213\pHT-P001\_MD 213.dgn

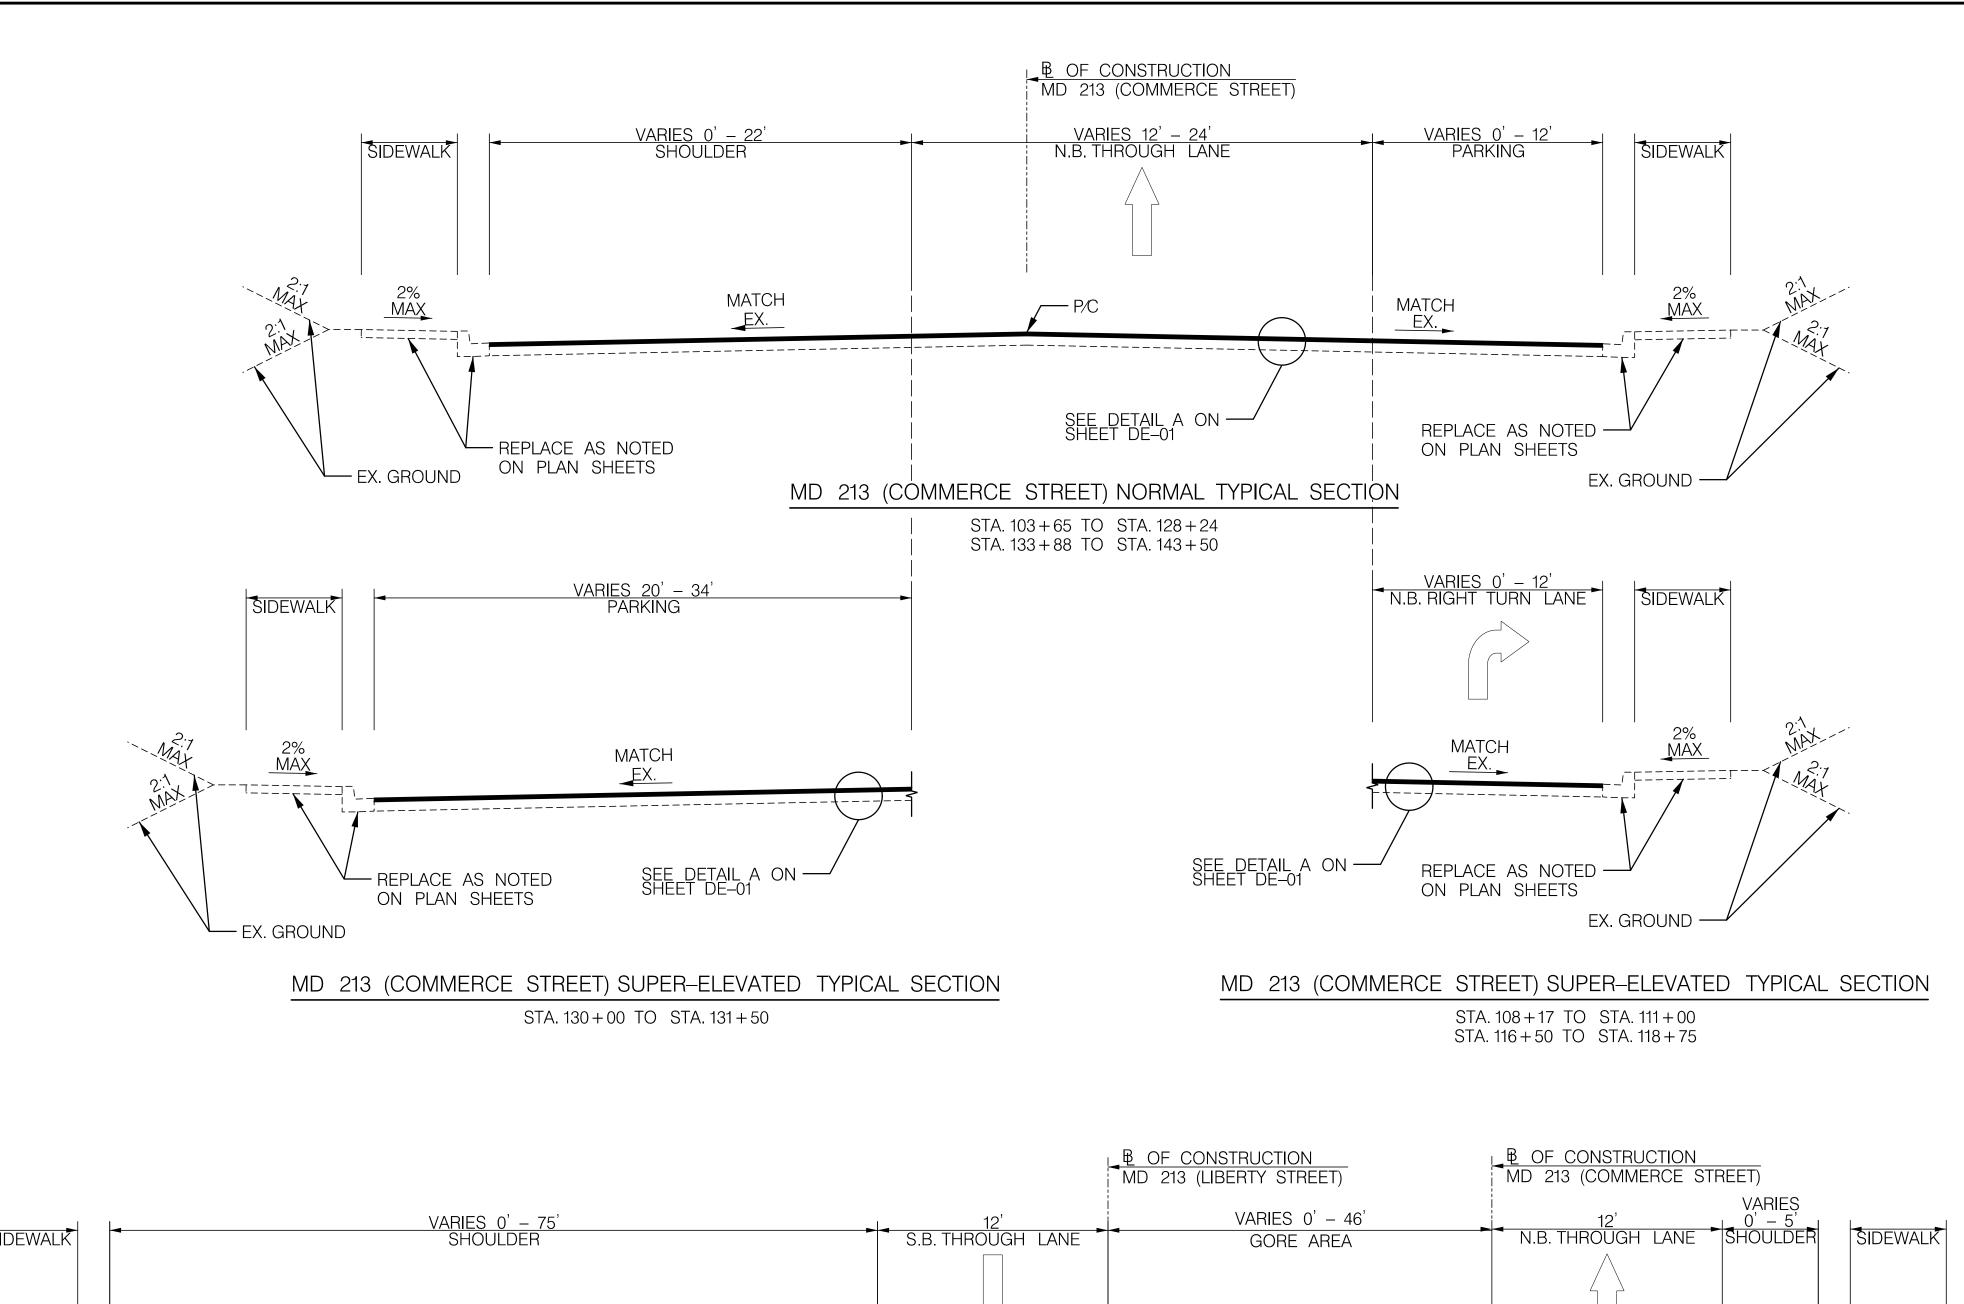

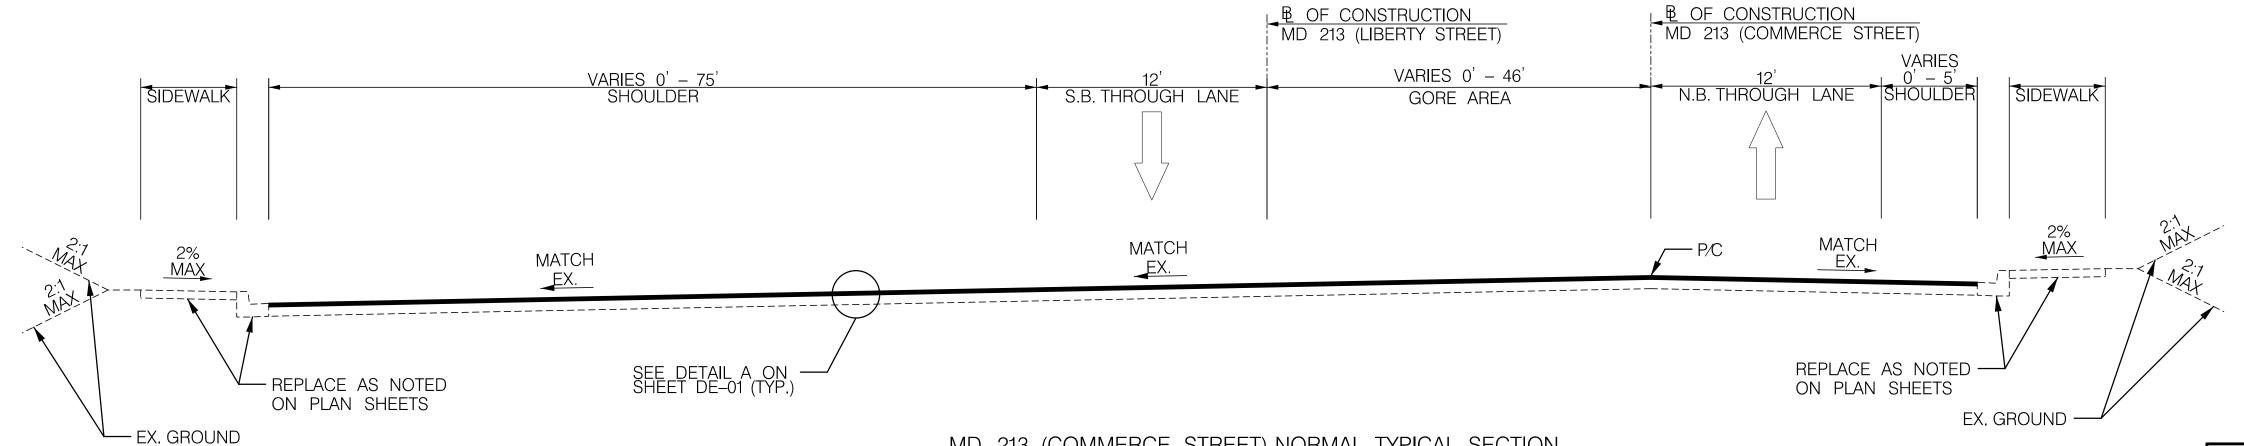

MD 213 (COMMERCE STREET) NORMAL TYPICAL SECTION

STA. 143 + 50 TO STA. 144 + 61




**ADMINISTRATION** 

DISTRICT 2 PROJECT DEVELOPMENT MD 213 (LIBERTY STREET AND COMMERCE STREET) FROM MILL STREAM BRANCH TO GRAVEL RUN SAFETY AND RESURFACING

509 South Exeter Street 4th Floor Baltimore, Maryland 21202


(410) 662-7400

R /W PLAT NUMBER	CROSS REFERENCE	REVISIONS	TYPICA	L SECTIONS
	ITEM SHEET NOs.  INDEX OF SHEETS 2		SCALE <u>N.T.S.</u> ADVERTISED DATE	DEC 2019 CONTRACT NO. QA2985177
	GENERAL NOTES SHEET       3         TYPICAL SECTIONS       4–5         DETAIL SHEET       6         GEOMETRIC LAYOUT SHEET       7         RAMP CONSTRUCTION DETAIL       8         SITE LAYOUT SHEET       9         ROADWAY PLANS       10–28         EROSION AND SEDIMENT CONTROL NOTES       29         MAINTENANCE OF TRAFFIC NOTES       30		DESIGNED BYDPK DRAWN BYPNK CHECKED BYGGW MDE/PRDEXEMPT	COUNTY QUEEN ANNE'S  LOGMILE 7,06 - 7,85  HORIZONTAL SCALE N/A  VERTICAL SCALE N/A
	WWW.TETWWYOL OF THEWTHO TYPILES		DRAWING NO. TS-02	OF TS-02 SHEET NO. 5 OF 30

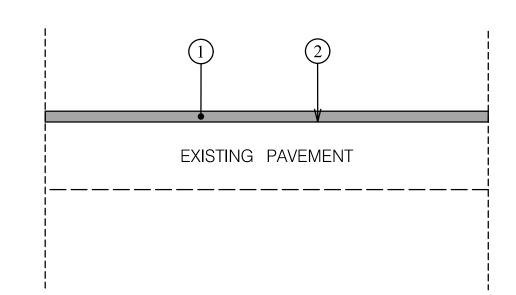

## <u>DETAIL A</u> <u>FINE MILLING AND RESURFACING</u>

NOT TO SCALE

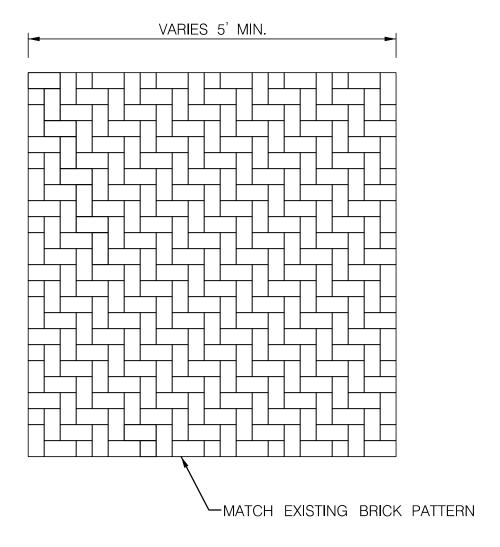

### <u>DETAIL B</u> <u>BRICK SIDEWALK</u>

NOT TO SCALE

#### NOTES:

- 1. CONTRACTOR SHALL USE CARE WHEN REMOVING EXISTING BRICKS AS TO NOT DAMAGE. BRICKS WILL BE STOCKPILED OUTSIDE OF THE PEDESTRIAN WALKWAY DURING CONSTRUCTION.
- 2. CONTRACTOR SHALL ADJUST GRADE TO ALLOW THE USE OF EXISTING BRICK WITHOUT CUTTING OR ALTERING. DETAIL "C" ON RD-01 HAS BEEN PROVIDED FOR THE CONTRACTOR'S USE FOR MAXIMUM SLOPES THAT CANNOT BE EXCEEDED.
- 3. BRICKS SHALL BE PLACED IN A PATTERN THAT MATCHES EXISTING CONDITIONS. BRICKS SHALL NOT BE CUT OR MODIFIED AT THE EXTENT OF THE CONSTRUCTION AREA AND SHOULD BE FITTED TO ACHIEVE UNIFORMITY THROUGH RECONSTRUCTED SIDEWALK.
- 4. IF DURING CONSTRUCTION SIDEWALK BRICKS ARE DAMAGED, CONTRACTOR SHALL COORDINATE WITH MDOT SHA TO DISCUSS THE APPROPRIATE COLOR AND PLACEMENT. CONTRACTOR IS RESPONSIBLE FOR THE BRICK PLACEMENT DURING CONSTRUCTION.



(410) 662-7400

## PAVEMENT LEGEND

- 2" SUPERPAVE ASPHALT MIX 12.5 mm FOR SURFACE, HDFV, PG 64S-22, LEVEL 2
- (2) TOP OF EXISTING PAVEMENT AFTER 2" FINE MILLING

### NOTES:

1. INFORMATION FROM CONSTRUCTION HISTORY AND PAVEMENT CORES INDICATES THE FOLLOWING EXISTING PAVEMENT STRUCTURE ON 213:

#### MAINLINE:

2" TO 6.5" BITUMINOUS CONCRETE OVER 6.3" – 9" JOINTED PLAIN CONCRETE PAVEMENT

#### SHOULDERS:

4" TO 5.5" BITUMINOUS CONCRETE OVER STONE

2. FOR FULL-DEPTH PATCHING, REFER TO STANDARD MD 578.03, USE THE FOLLOWING:

VARIABLE DEPTH SUPERPAVE ASPHALT MIX 19.0MM FOR FULL-DEPTH PATCH, PG 64S-22, LEVEL 2

NOTE: FULL-DEPTH PATCHES MUST MATCH THE EXISTING ASPHALT THICKNESS OR THEY MUST BE 9". WHICHEVER IS THICKER.

IF THE UNDERLYING SUB-BASE LAYER IS DETERIORATED AT THE TIME OF FULL-DEPTH PATCH EXCAVATION, IT SHOULD BE REMOVED AND REPLACED WITH 6" GRADED AGGREGATE BASE COURSE.


- FOR NEW CURB AND COMBINATION CURB AND GUTTER USE STANDARD 580.03, 620.02, AND 620.02-01.
- IF WEDGE / LEVEL IS NEEDED TO MAKE GRADE OR CROSS SLOPE ADJUSTMENT USE THE FOLLOWING:

SUPERPAVE ASPHALT MIX 9.5MM FOR WEDGE / LEVEL, PG 64S-22, LEVEL 2 (1" MIN AND 2" MAX LIFT THICKNESS)



DISTRICT 2
PROJECT DEVELOPMENT
MD 213 (LIBERTY STREET AND
COMMERCE STREET)
FROM MILL STREAM BRANCH
TO GRAVEL RUN
SAFETY AND RESURFACING


		_	<u></u>
R /W PLAT NUMBER	CROSS REFERENCE	REVISIONS	DETAIL SHEET
	ITEM SHEET NOs.  INDEX OF SHEETS 2	-	SCALE AS SHOWN ADVERTISED DATE DEC 2019 CONTRACT NO. QA2985177
	GENERAL NOTES SHEET       3         TYPICAL SECTIONS       4–5         DETAIL SHEET       6         GEOMETRIC LAYOUT SHEET       7         RAMP CONSTRUCTION DETAIL       8         SITE LAYOUT SHEET       9         ROADWAY PLANS       10–28         EROSION AND SEDIMENT CONTROL NOTES       29         MAINTENANCE OF TRAFFIC NOTES       30		DESIGNED BY         DPK         COUNTY         QUEEN ANNE'S           DRAWN BY         PNK         LOGMILE         7.06 - 7.85           CHECKED BY         GGW         HORIZONTAL SCALE         N/A           MDE/PRD         EXEMPT         VERTICAL SCALE         N/A
	MAINTENANCE OF TRAFFIC NOTES		DRAWING NO. DE-01 OF DE-01 SHEET NO. 6 OF 30

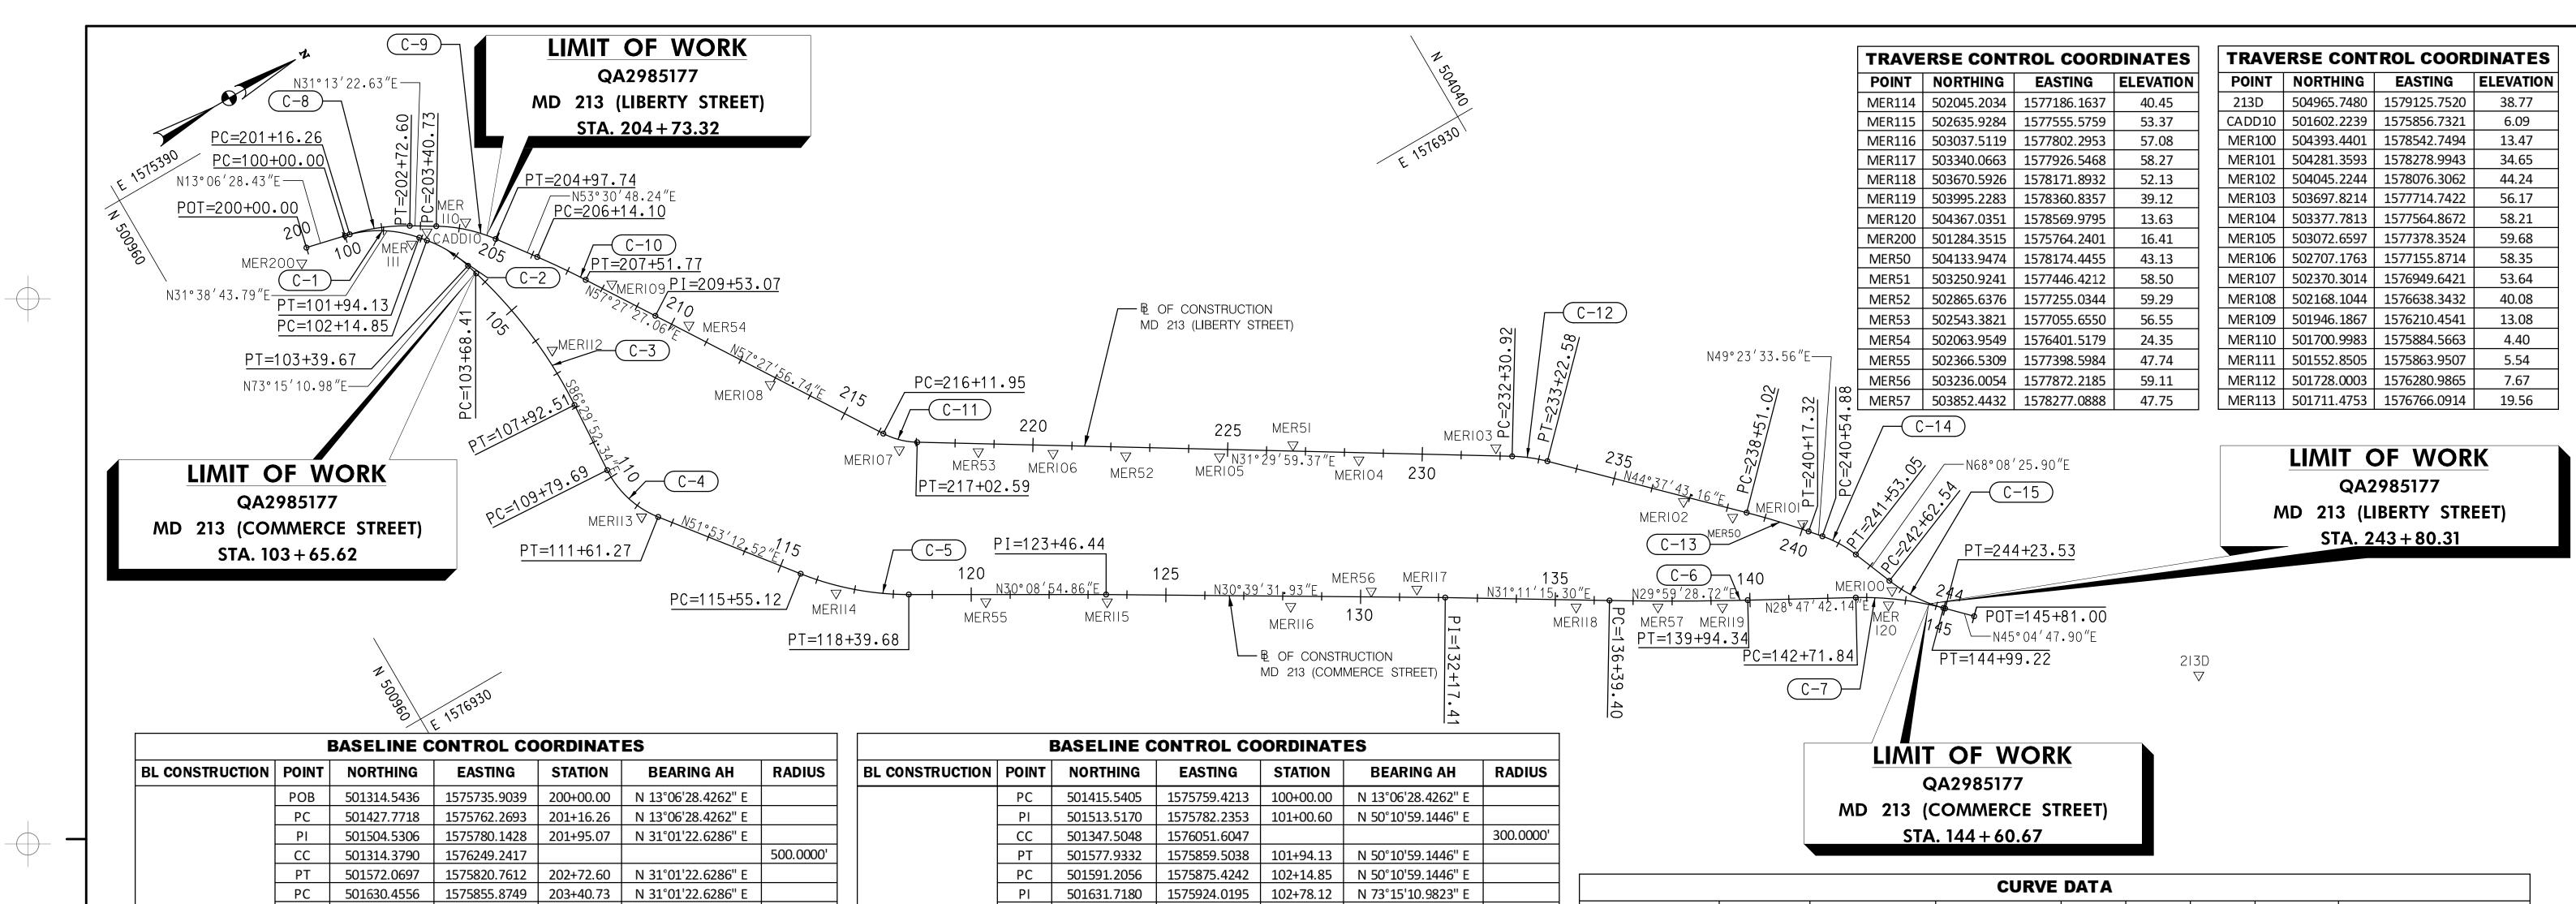

BL CONSTRUCTION	POINT	NORTHING	EASTING	STATION	BEARING AH	RADIUS
	РОВ	501314.5436	1575735.9039	200+00.00	N 13°06'28.4262" E	
	PC	501427.7718	1575762.2693	201+16.26	N 13°06'28.4262" E	
	PI	501504.5306	1575780.1428	201+95.07	N 31°01'22.6286" E	
	CC	501314.3790	1576249.2417			500.0000'
	PT	501572.0697	1575820.7612	202+72.60	N 31°01'22.6286" E	
	PC	501630.4556	1575855.8749	203+40.73	N 31°01'22.6286" E	
	PI	501698.6100	1575896.8633	204+20.26	N 53°30'48.2382" E	
	CC	501424.3031	1576198.6593			400.0000
	PT	501745.9014	1575960.8053	204+97.74	N 53°30'48.2382" E	
	PC	501815.0914	1576054.3559	206+14.10	N 53°30'48.2382" E	
	PI	501856.0409	1576109.7231	206+82.96	N 57°27'27.0617" E	
	CC	500207.0995	1577243.6254			2000.0000
	PT	501893.0851	1576167.7758	207+51.77	N 57°27'27.0617" E	
	PI	502001.3654	1576337.4640	209+53.07	N 57°27'56.7442" E	
	PC	502355.7165	1576892.9510	216+11.95	N 57°27'56.7442" E	
MD 213	PI	502380.5151	1576931.8258	216+58.06	N 31°29'59.3708" E	
(LIBERTY STREET)	СС	502524.3305	1576785.3903			200.0000
(LIDENTI STREET)	PT	502419.8313	1576955.9187	217+02.59	N 31°29'59.3708" E	
	PC	503722.9508	1577754.4659	232+30.92	N 31°29'59.3708" E	
	PI	503762.1978	1577778.5163	232+76.95	N 44°37'43.1585" E	
	CC	503513.9525	1578095.5226			400.0000
	PT	503794.9561	1577810.8527	233+22.58	N 44°37'43.1585" E	
	PC	504171.0382	1578182.0912	238+51.02	N 44°37'43.1585" E	
	PI	504230.2463	1578240.5367	239+34.22	N 49°23'33.5590" E	
	CC	502766.0201	1579605.4408			2000.0000
	PT	504284.3958	1578303.6977	240+17.32	N 49°23'33.5590" E	
	PC	504308.8454	1578332.2161	240+54.88	N 49°23'33.5590" E	
	PI	504341.0795	1578369.8145	241+04.41	N 68°08'25.8992" E	
	CC	504081.0891	1578527.4776			300.0000
	PT	504359.5190	1578415.7782	241+53.05	N 68°08'25.8992" E	
	PC	504400.2859	1578517.3965	242+62.54	N 68°08'25.8992" E	
	PI	504430.6685	1578593.1304	243+44.14	N 45°04'47.8998" E	
	СС	504771.5258	1578368.4639			400.0000'

BASELINE CONTROL COORDINATES								
BL CONSTRUCTION	POINT	NORTHING	EASTING	STATION	BEARING AH	RADIUS		
	PC	501415.5405	1575759.4213	100+00.00	N 13°06'28.4262" E			
	PI	501513.5170	1575782.2353	101+00.60	N 50°10'59.1446" E			
	CC	501347.5048	1576051.6047			300.0000'		
	PT	501577.9332	1575859.5038	101+94.13	N 50°10'59.1446" E			
	PC	501591.2056	1575875.4242	102+14.85	N 50°10'59.1446" E			
	PI	501631.7180	1575924.0195	102+78.12	N 73°15'10.9823" E			
	CC	501353.0963	1576073.9285			310.0000'		
	PT	501649.9482	1575984.6034	103+39.67	N 73°15'10.9823" E			
	PC	501658.2296	1576012.1250	103+68.41	N 73°15'10.9823" E			
	PI	501719.9742	1576217.3194	105+82.70	S 86°29'52.3419" E			
	CC	500509.1256	1576357.8994			1200.0000'		
	PT	501706.8846	1576431.2021	107+92.51	S 86°29'52.3419" E			
	PC	501695.4506	1576618.0319	109+79.69	S 86°29'52.3419" E			
	PI	501689.6472	1576712.8589	110+74.69	N 51°53'12.5154" E			
MD 213	СС	501944.9838	1576633.3033			250.0000'		
(COMMERCE STREET)	PT	501748.2855	1576787.6076	111+61.27	N 51°53'12.5154" E			
(COMMENCE STREET)	PC	501991.3789	1577097.4891	115+55.12	N 51°53'12.5154" E			
	PI	502080.2631	1577210.7936	116+99.13	N 30°08'54.8565" E			
	CC	502581.4736	1576634.5763			750.0000'		
	PT	502204.7906	1577283.1208	118+39.68	N 30°08'54.8565" E			
	PI	502642.9985	1577537.6375	123+46.44	N 30°39'31.9315" E			
	PI	503392.2241	1577981.7680	132+17.41	N 31°11'15.2982" E			
	PC	503753.2269	1578200.2922	136+39.40	N 31°11'15.2982" E			
	PI	503905.0708	1578292.2072	138+16.89	N 28°47'42.1390" E			
	CC	508154.8807	1570928.7419			8500.0000		
	PT	504060.6195	1578377.7032	139+94.34	N 28°47'42.1390" E			
	PC	504303.8066	1578511.3690	142+71.84	N 28°47'42.1390" E			
	PI	504404.1151	1578566.5028	143+86.30	N 45°04'47.8998" E			
	СС	503918.4644	1579212.4478			800.0000'		
	PT	504484.9388	1578647.5525	144+99.22	N 45°04'47.8998" E			
	POE	504542.6883	1578705.4634	145+81.00				

CURVE DATA									
BASELINE CONSTRUCTION	CURVE NO.	DELTA	Dc	R	т	L	E	CENTER OF CURVE	
CONSTRUCTION								NORTHING	EASTING
	C-1	37°04'30.7182"	19°05'54.9353"	300.0000'	100.5976'	194.1253'	16.4172	501347.5048	1576051.6047
	C-2	23°04'11.8380"	18°28'57.0342"	310.0000'	63.2673'	124.8205'	6.3902	501353.0963	1576073.9285
MD 213	C-3	20°14'56.6755"	4°46'28.7338"	1200.000	214.2828'	424.0957'	18.982	500509.1256	1576357.8994
(COMMERCE STREET)	C-4	41°36'55.1425"	22°55'05.9225"	250.0000'	95.0043'	181.5811'	17.4431	501944.9838	1576633.3033
(COMMERCE STREET)	C-5	21°44'17.6591"	7°38'21.9741"	750.0000'	144.0081'	284.5529'	13.7004	502581.4736	1576634.5763
	C-6	2°23'33.1592"	0°40'26.6448"	8500.000	177.4963'	354.9411'	1.853	508154.8807	1570928.7419
	C-7	16°17'05.7608"	7°09'43.1008"	800.0000'	114.4619'	227.3806'	8.147	503918.4644	1579212.4478
	C-8	17°54'54.2024"	11°27'32.9612"	500.0000'	78.8123'	156.3384'	6.1733	501314.3790	1576249.2417
	C-9	22°29'25.6095"	14°19'26.2016"	400.0000'	79.5303'	157.0129'	7.8297	501424.3031	1576198.6593
	C-10	3°56'38.8235"	2°51'53.2403"	2000.000	68.8650'	137.6757'	1.1852	500207.0995	1577243.6254
MD 213	C-11	25°57'57.3732"	28°38'52.4031"	200.0000'	46.1110'	90.6382'	5.2467	502524.3305	1576785.3903
(LIBERTY STREET)	C-12	13°07'43.7877"	14°19'26.2016"	400.0000'	46.0298'	91.6565'	2.6397	503513.9525	1578095.5226
	C-13	4°45'50.4005"	2°51'53.2403"	2000.000	83.1954'	166.2950'	1.7296	502766.0201	1579605.4408
	C-14	18°44'52.3402"	19°05'54.9353"	300.0000'	49.5245'	98.1636'	4.0603	504081.0891	1578527.4776
	C-15	23°03'37.9994"	14°19'26.2016"	400.0000'	81.6011'	160.9930'	8.2386	504771.5258	1578368.4639

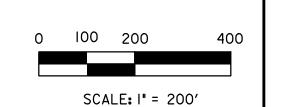

MARYLAND DEPARTMENT OF TRANSPORTATION STATE HIGHWAY


**ADMINISTRATION** 

DISTRICT 2 PROJECT DEVELOPMENT MD 213 (LIBERTY STREET AND COMMERCE STREET) FROM MILL STREAM BRANCH TO GRAVEL RUN SAFETY AND RESURFACING


McCORMICK TAYLOR

509 South Exeter Street 4th Floor Baltimore, Maryland 21202 (410) 662-7400


R /W PLAT NUMBER	CROSS REFERENCE	REVISIONS	GEOMETRI	C LAYOUT SHEET
	ITEM SHEET NOs. INDEX OF SHEETS 2		SCALE 1" = 200' ADVERTISED DAT	E DEC 2019 CONTRACT NO. QA2985177
	GENERAL NOTES SHEET       3         TYPICAL SECTIONS       4–5         DETAIL SHEET       6         GEOMETRIC LAYOUT SHEET       7         RAMP CONSTRUCTION DETAIL       8         SITE LAYOUT SHEET       9         ROADWAY PLANS       10–28         EROSION AND SEDIMENT CONTROL NOTES       29         MAINTENANCE OF TRAFFIC NOTES       30		DESIGNED BY DPK  DRAWN BY PNK  CHECKED BY GGW  MDE/PRD EXEMPT	COUNTY QUEEN ANNE'S  LOGMILE 7.06 - 7.85  HORIZONTAL SCALE N/A  VERTICAL SCALE N/A
	MAINTENANCE OF TRAFFIC NOTES		DRAWING NO. GS-	01 OF GS-01 SHEET NO. 7 OF 30

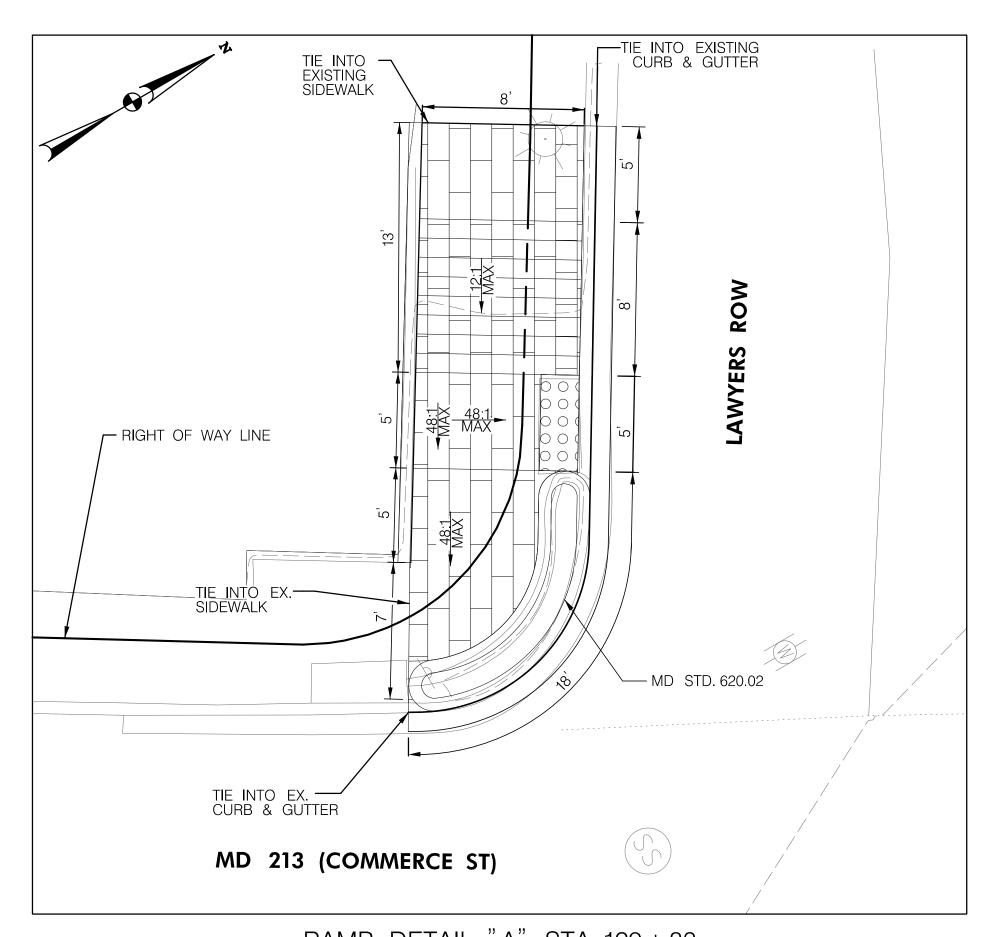


RAMP DETAIL "A" STA. 129 + 83

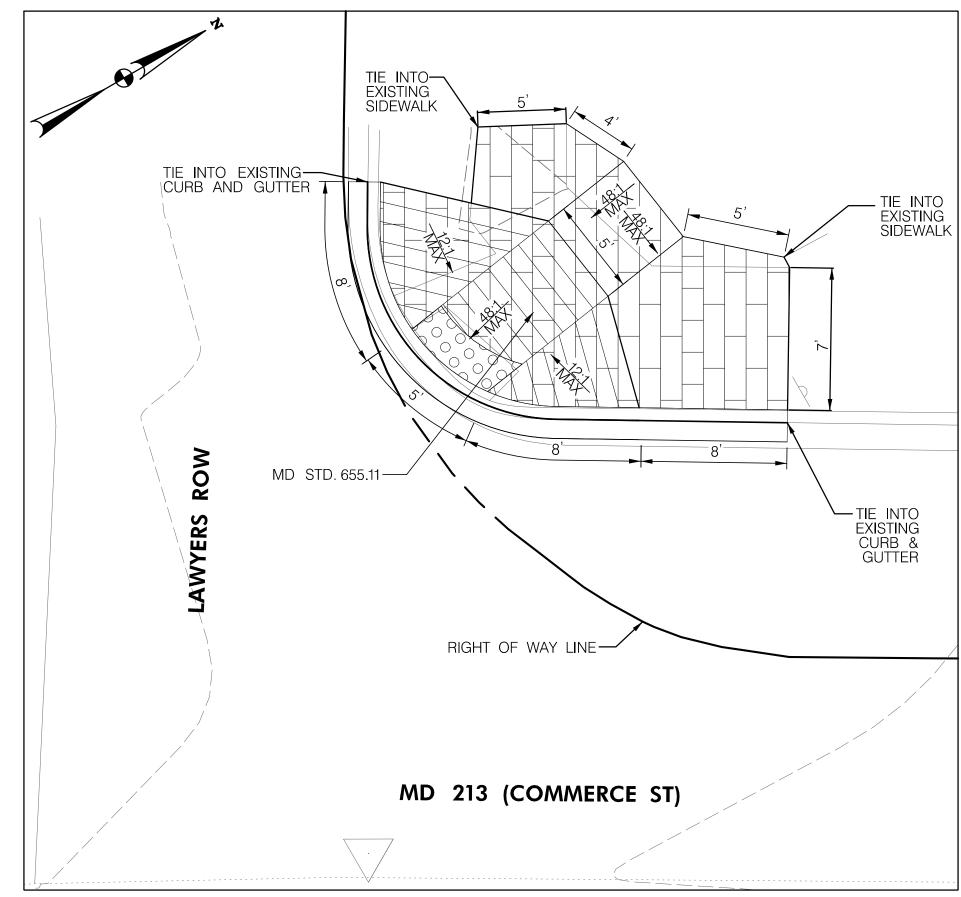


RAMP DETAIL "B" STA. 130 + 32

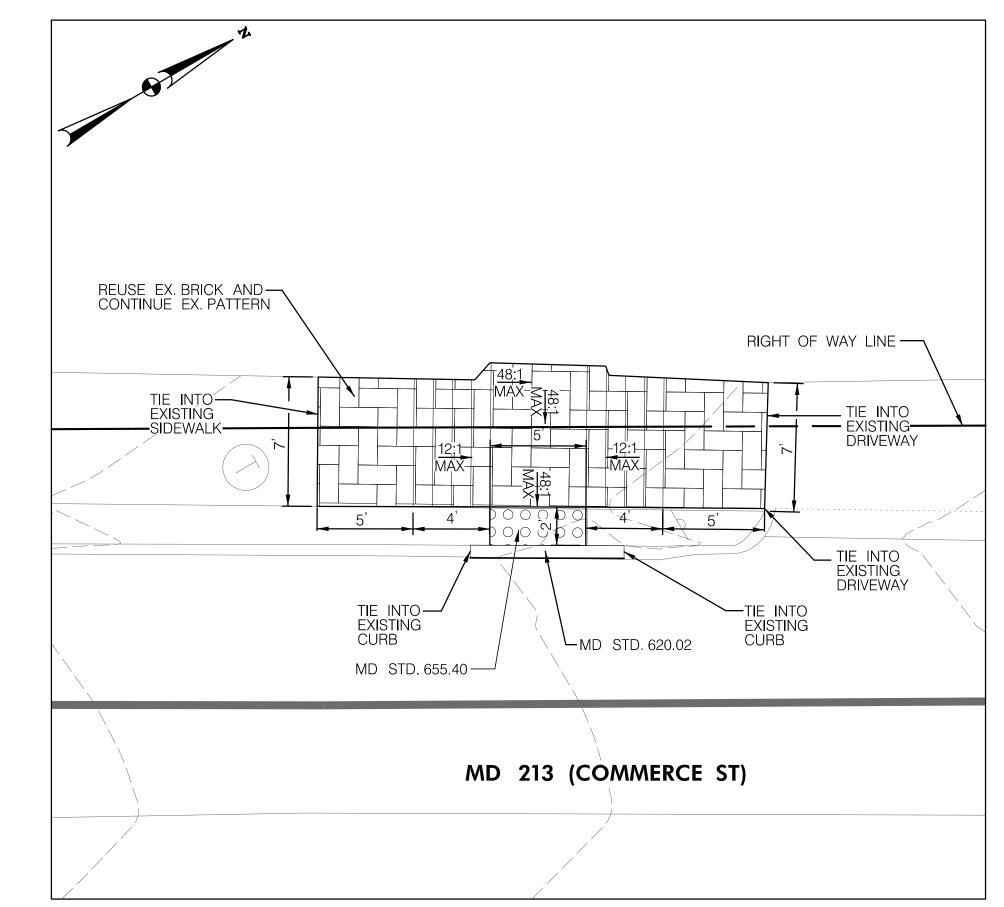


RAMP DETAIL "C" STA. 137 + 79

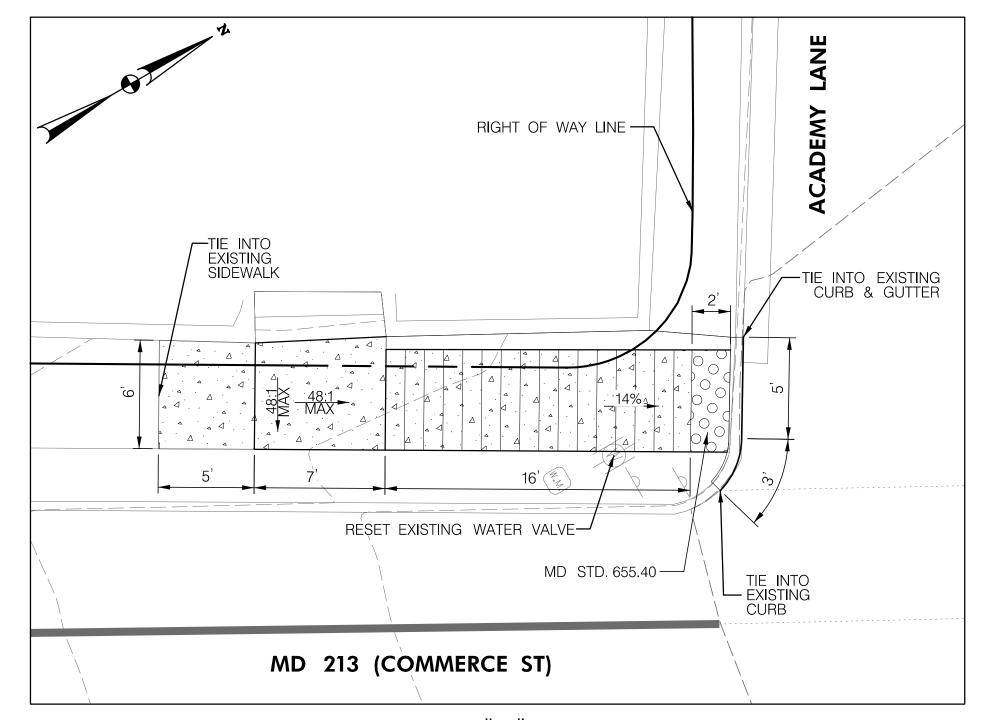

RAMP DETAIL "D" STA. 138 + 00

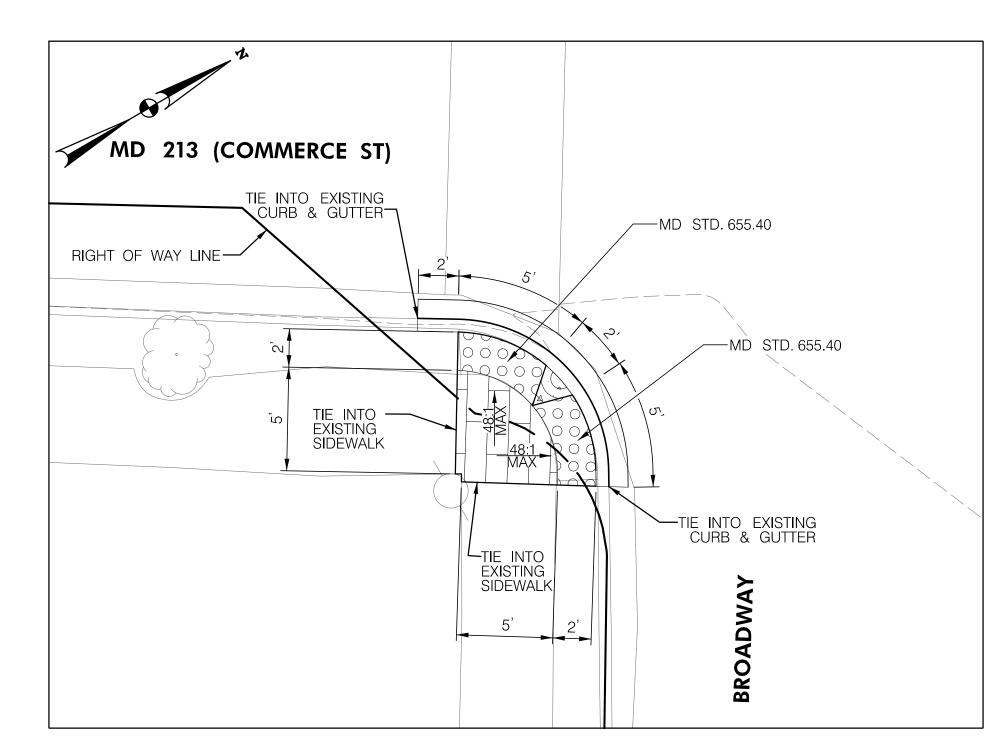

RAMP DETAIL "E" STA. 229+90

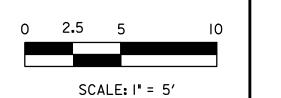

MARYLAND DEPARTMENT OF TRANSPORTATION

STATE HIGHWAY ADMINISTRATION

DRAWING NO.

DISTRICT 2
PROJECT DEVELOPMENT
MD 213 (LIBERTY STREET AND
COMMERCE STREET)
FROM MILL STREAM BRANCH
TO GRAVEL RUN
SAFETY AND RESURFACING

SHEET NO. 8 OF 30


McCORMICK TAYLOR 509 South Exeter Street


509 South Exeter Street 4th Floor Baltimore, Maryland 21202 (410) 662-7400


R /W PLAT NUMBER	CROSS REFERENCE	REVISIONS
	ITEM SHEET NOS.  INDEX OF SHEETS 2 GENERAL NOTES SHEET 3 TYPICAL SECTIONS 4–5 DETAIL SHEET 6 GEOMETRIC LAYOUT SHEET. 7 RAMP CONSTRUCTION DETAIL 8 SITE LAYOUT SHEET 9	
	ROADWAY PLANS	


RAMI	CONSTRU	CTION DETA	AIL SHEET
CALE <u>1" = 5'</u>	ADVERTISED DATE_	DEC 2019 CONTRA	ACT NOQA2985177
ESIGNED BY	DPK	COUNTY	QUEEN ANNE'S
RAWN BY	PNK	LOGMILE	7.06 - 7.85
HECKED BY	GGW	HORIZONTAL SO	CALEN/A
DE/PRD	EXEMPT	VERTICAL SCAL	EN/A


RC-01 OF RC-01

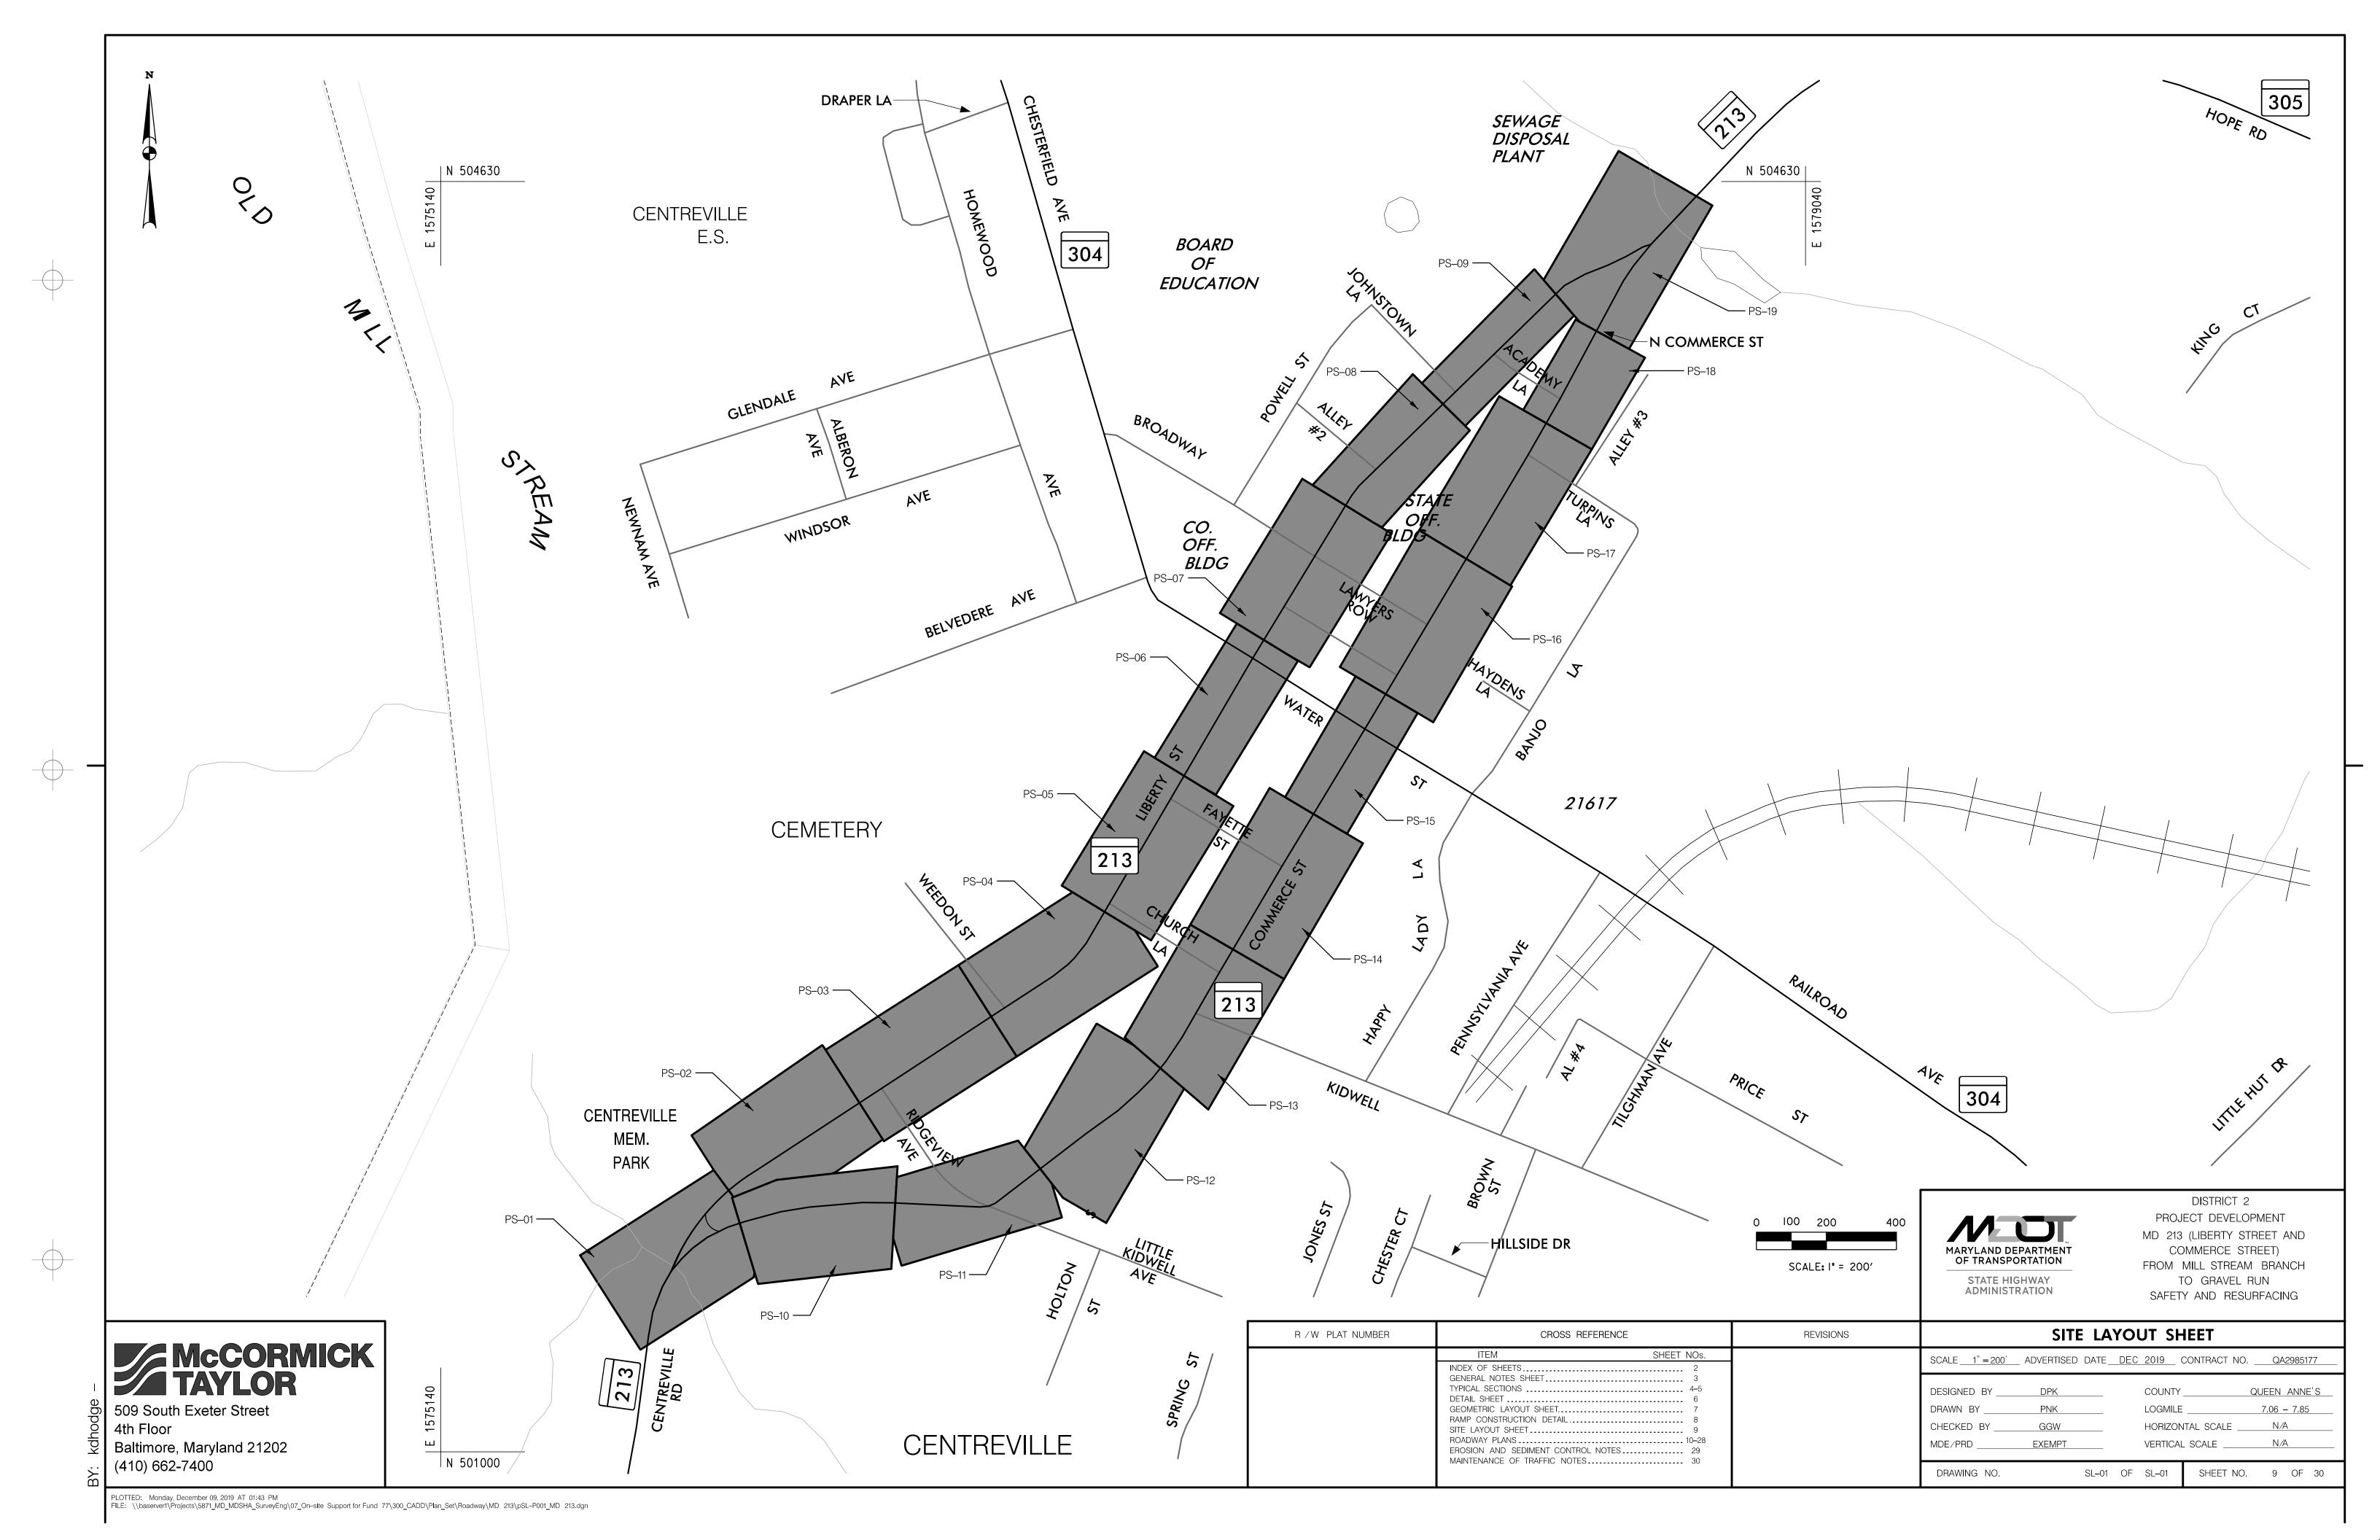


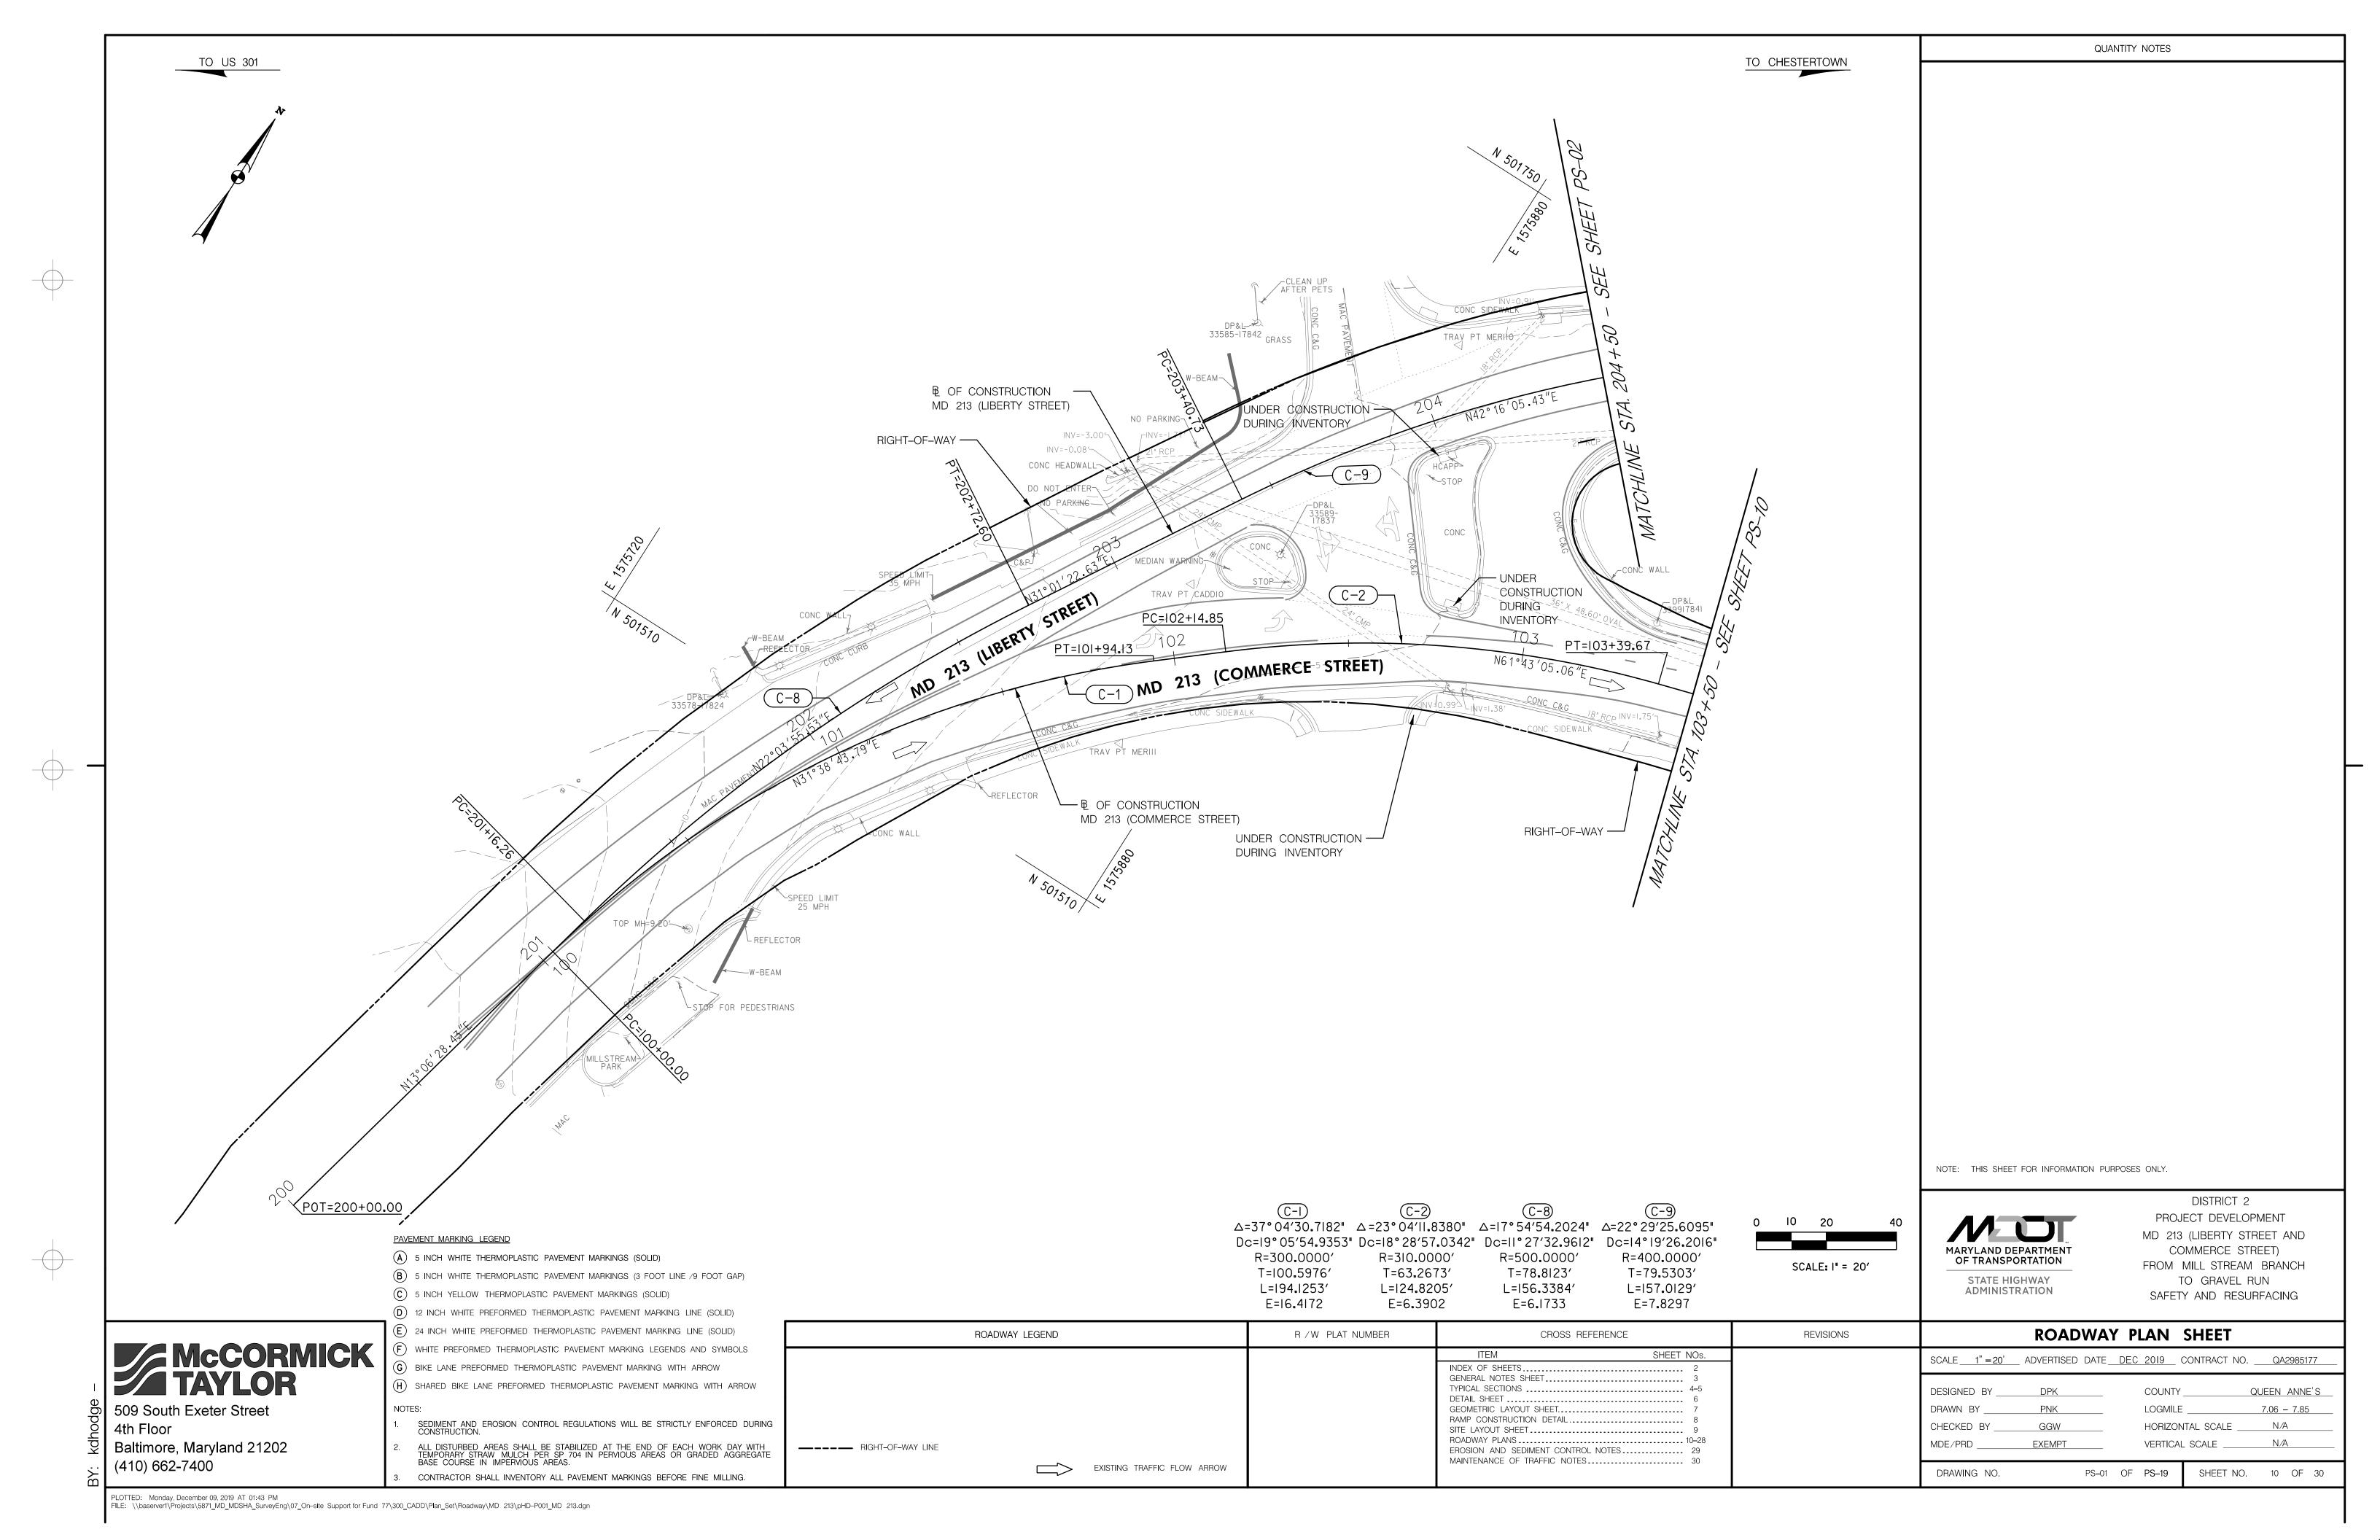

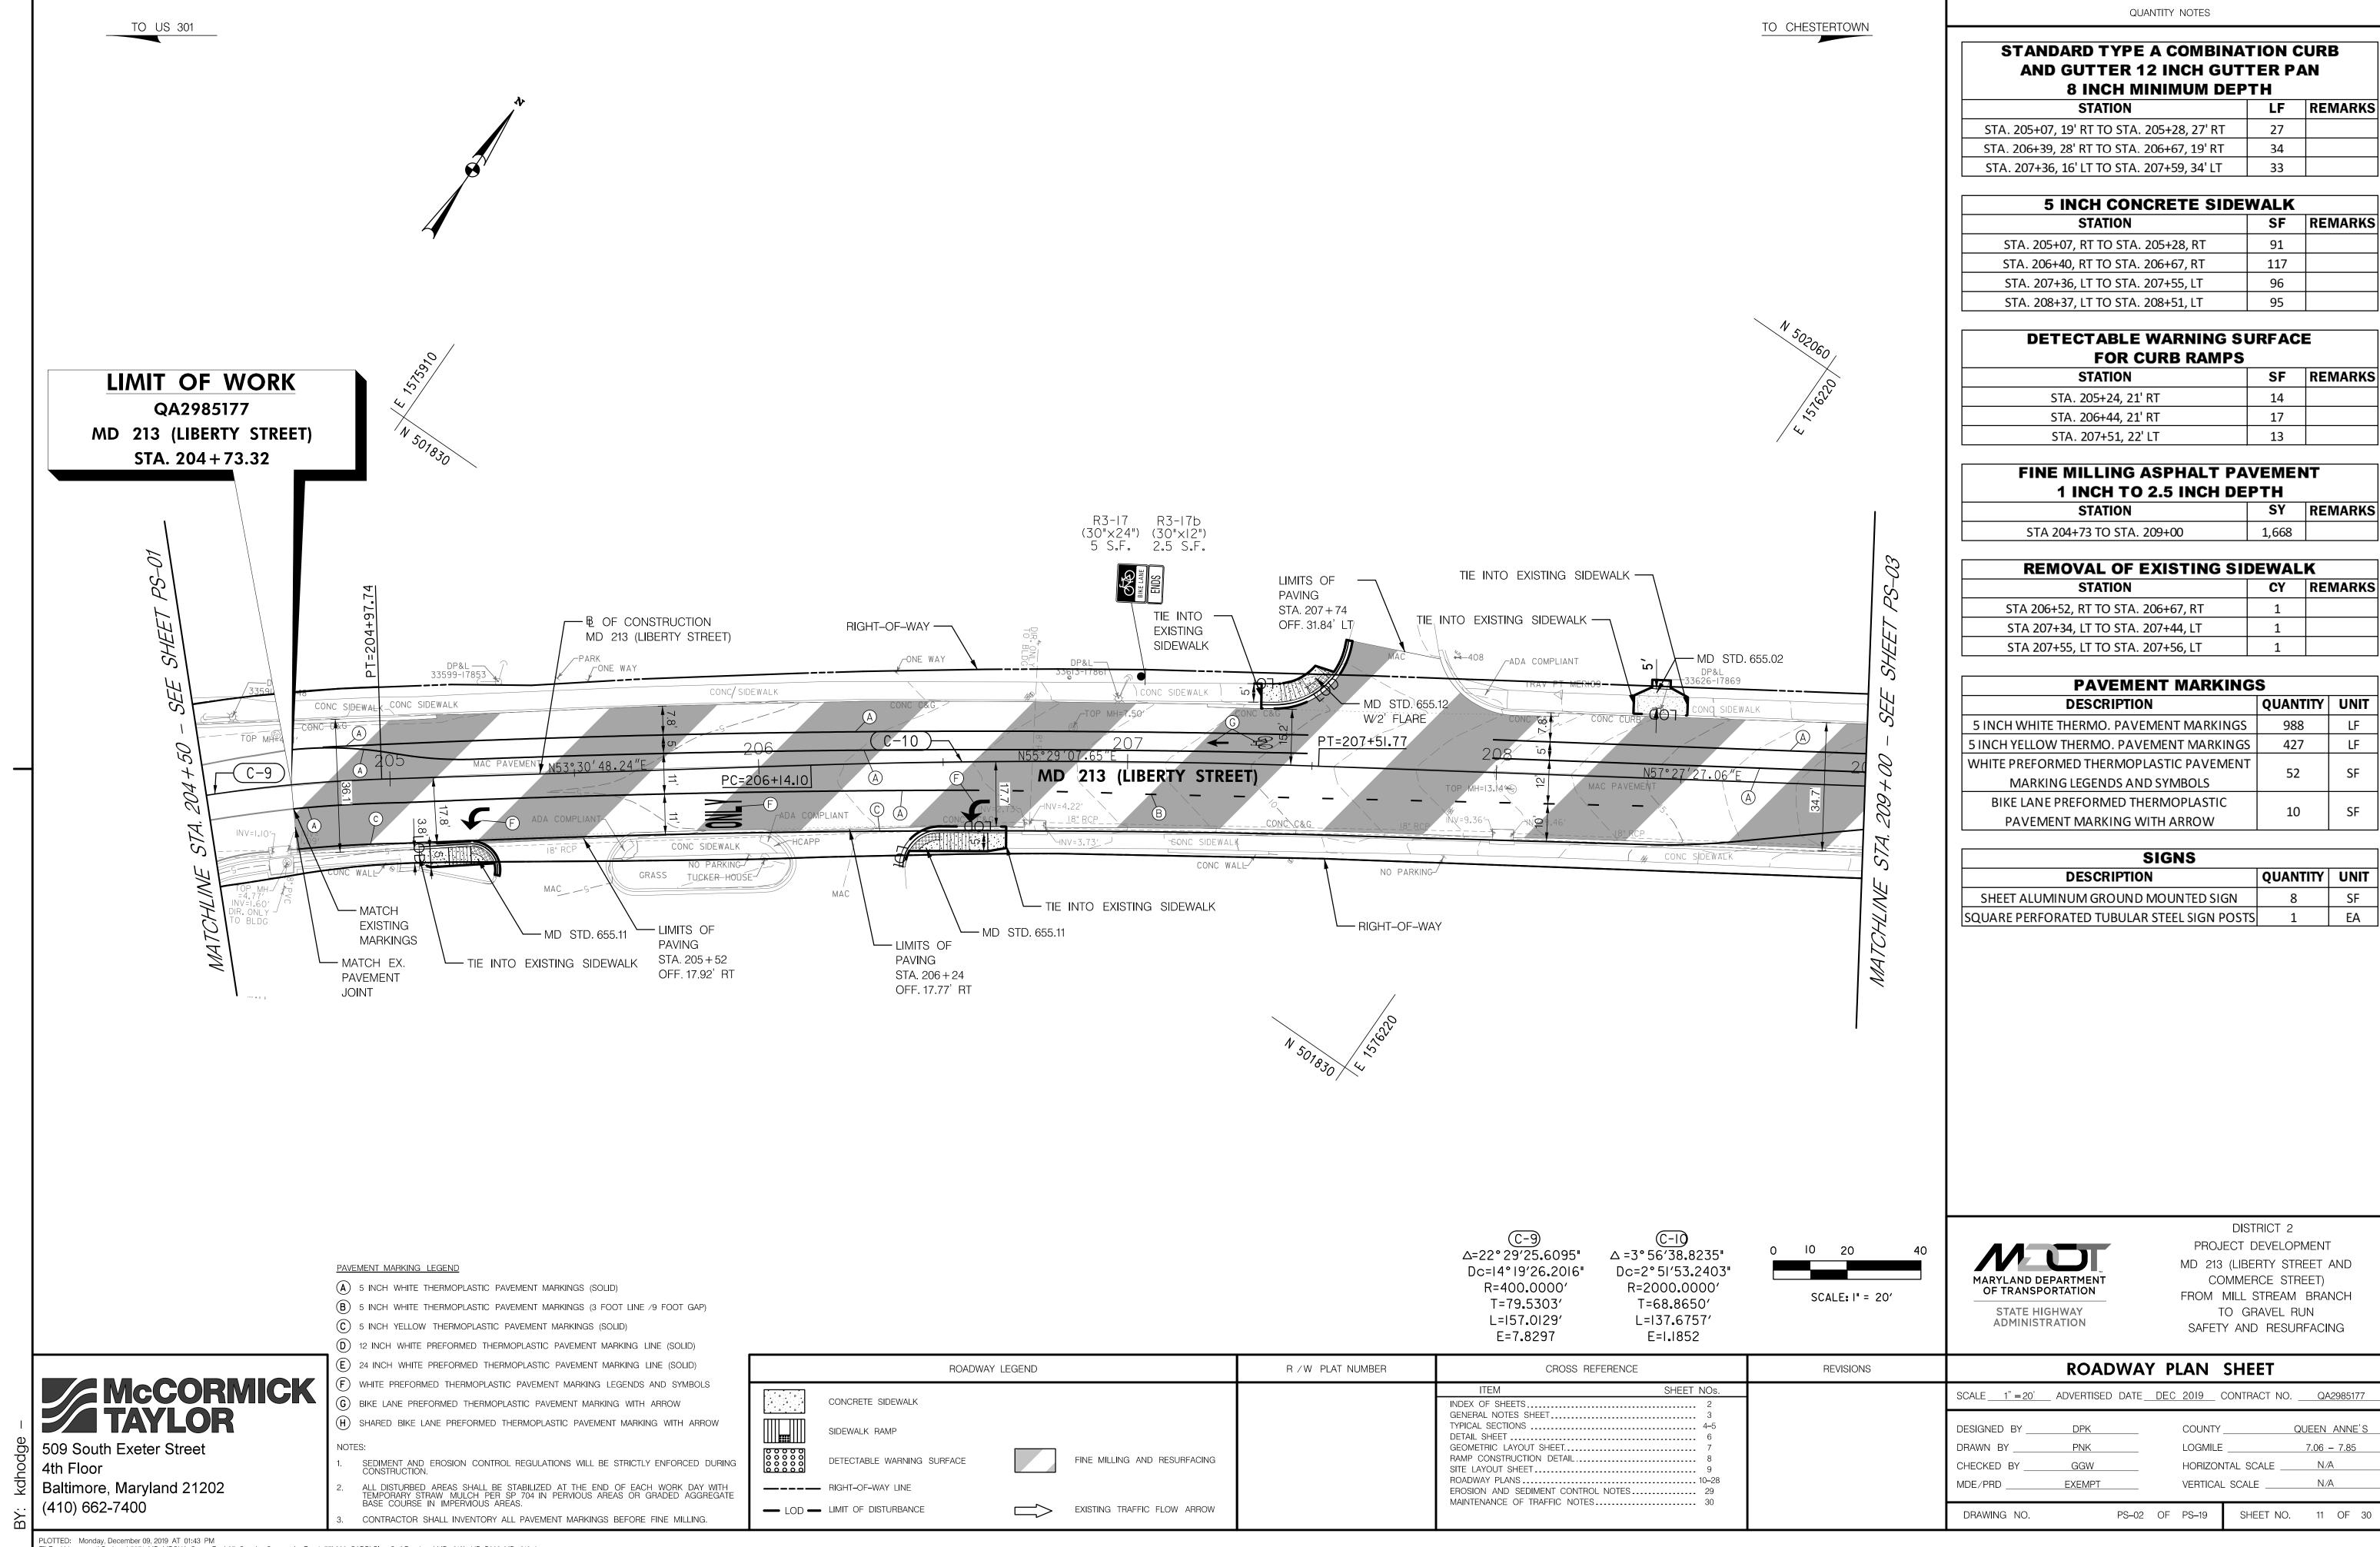

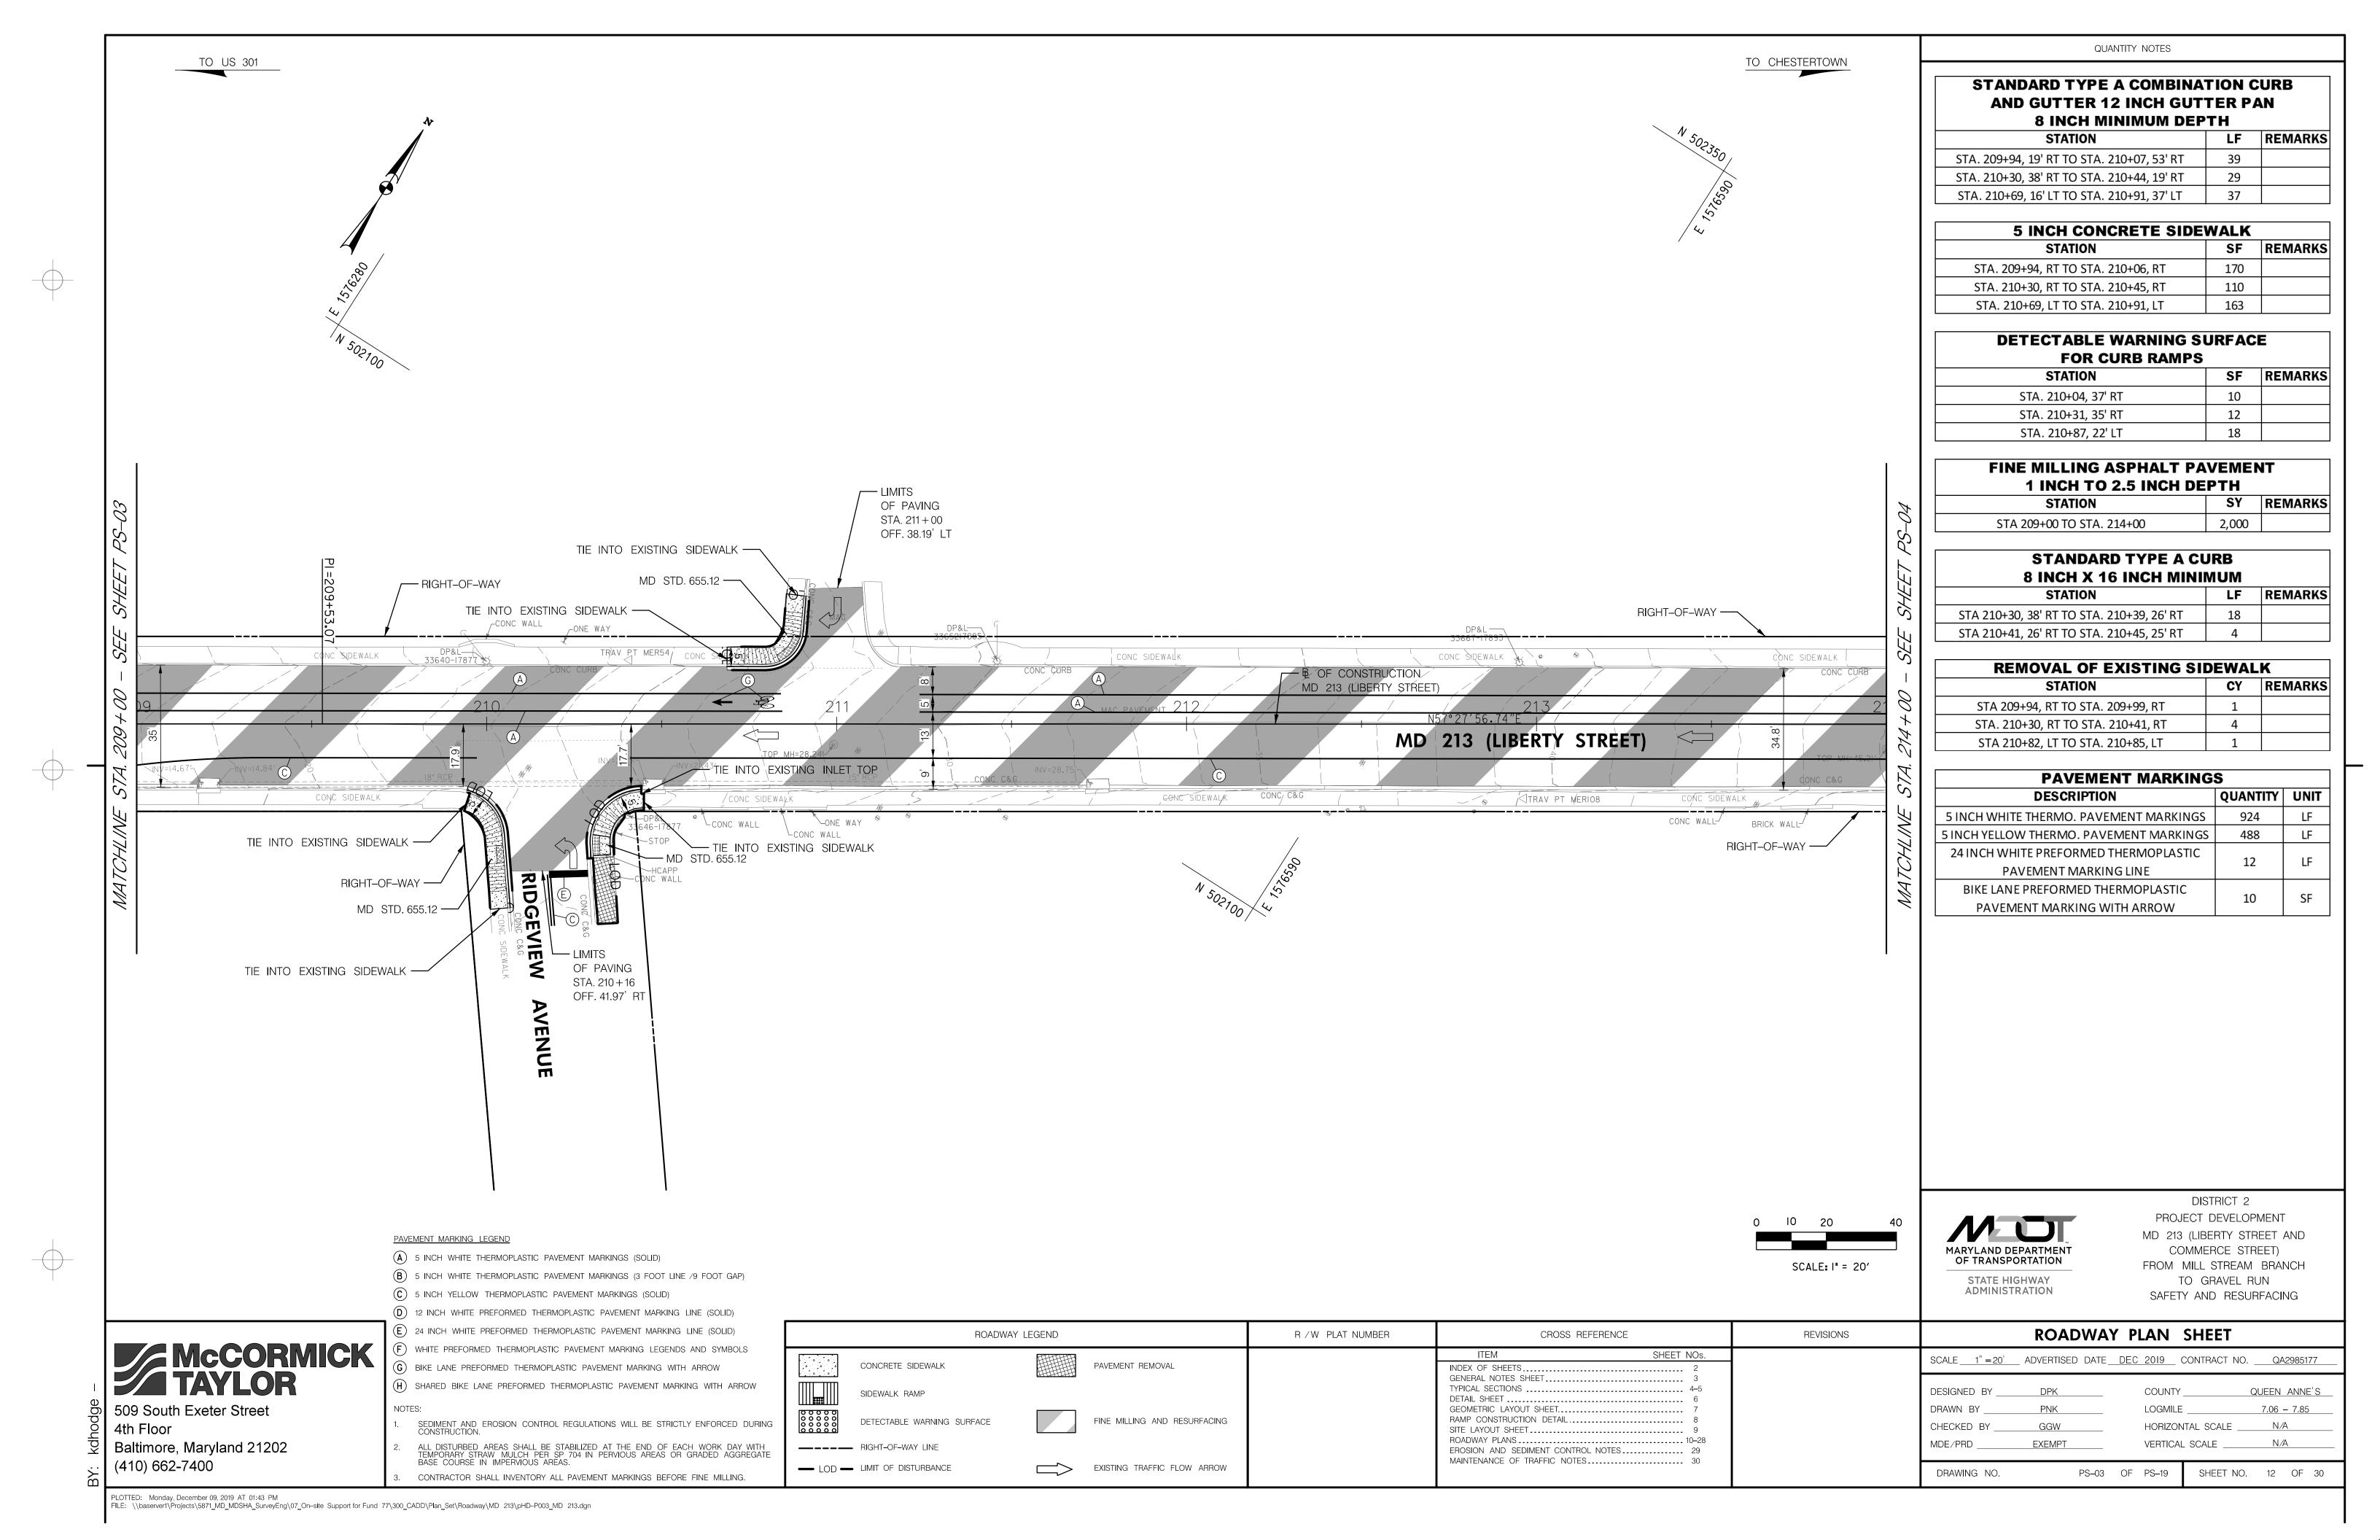

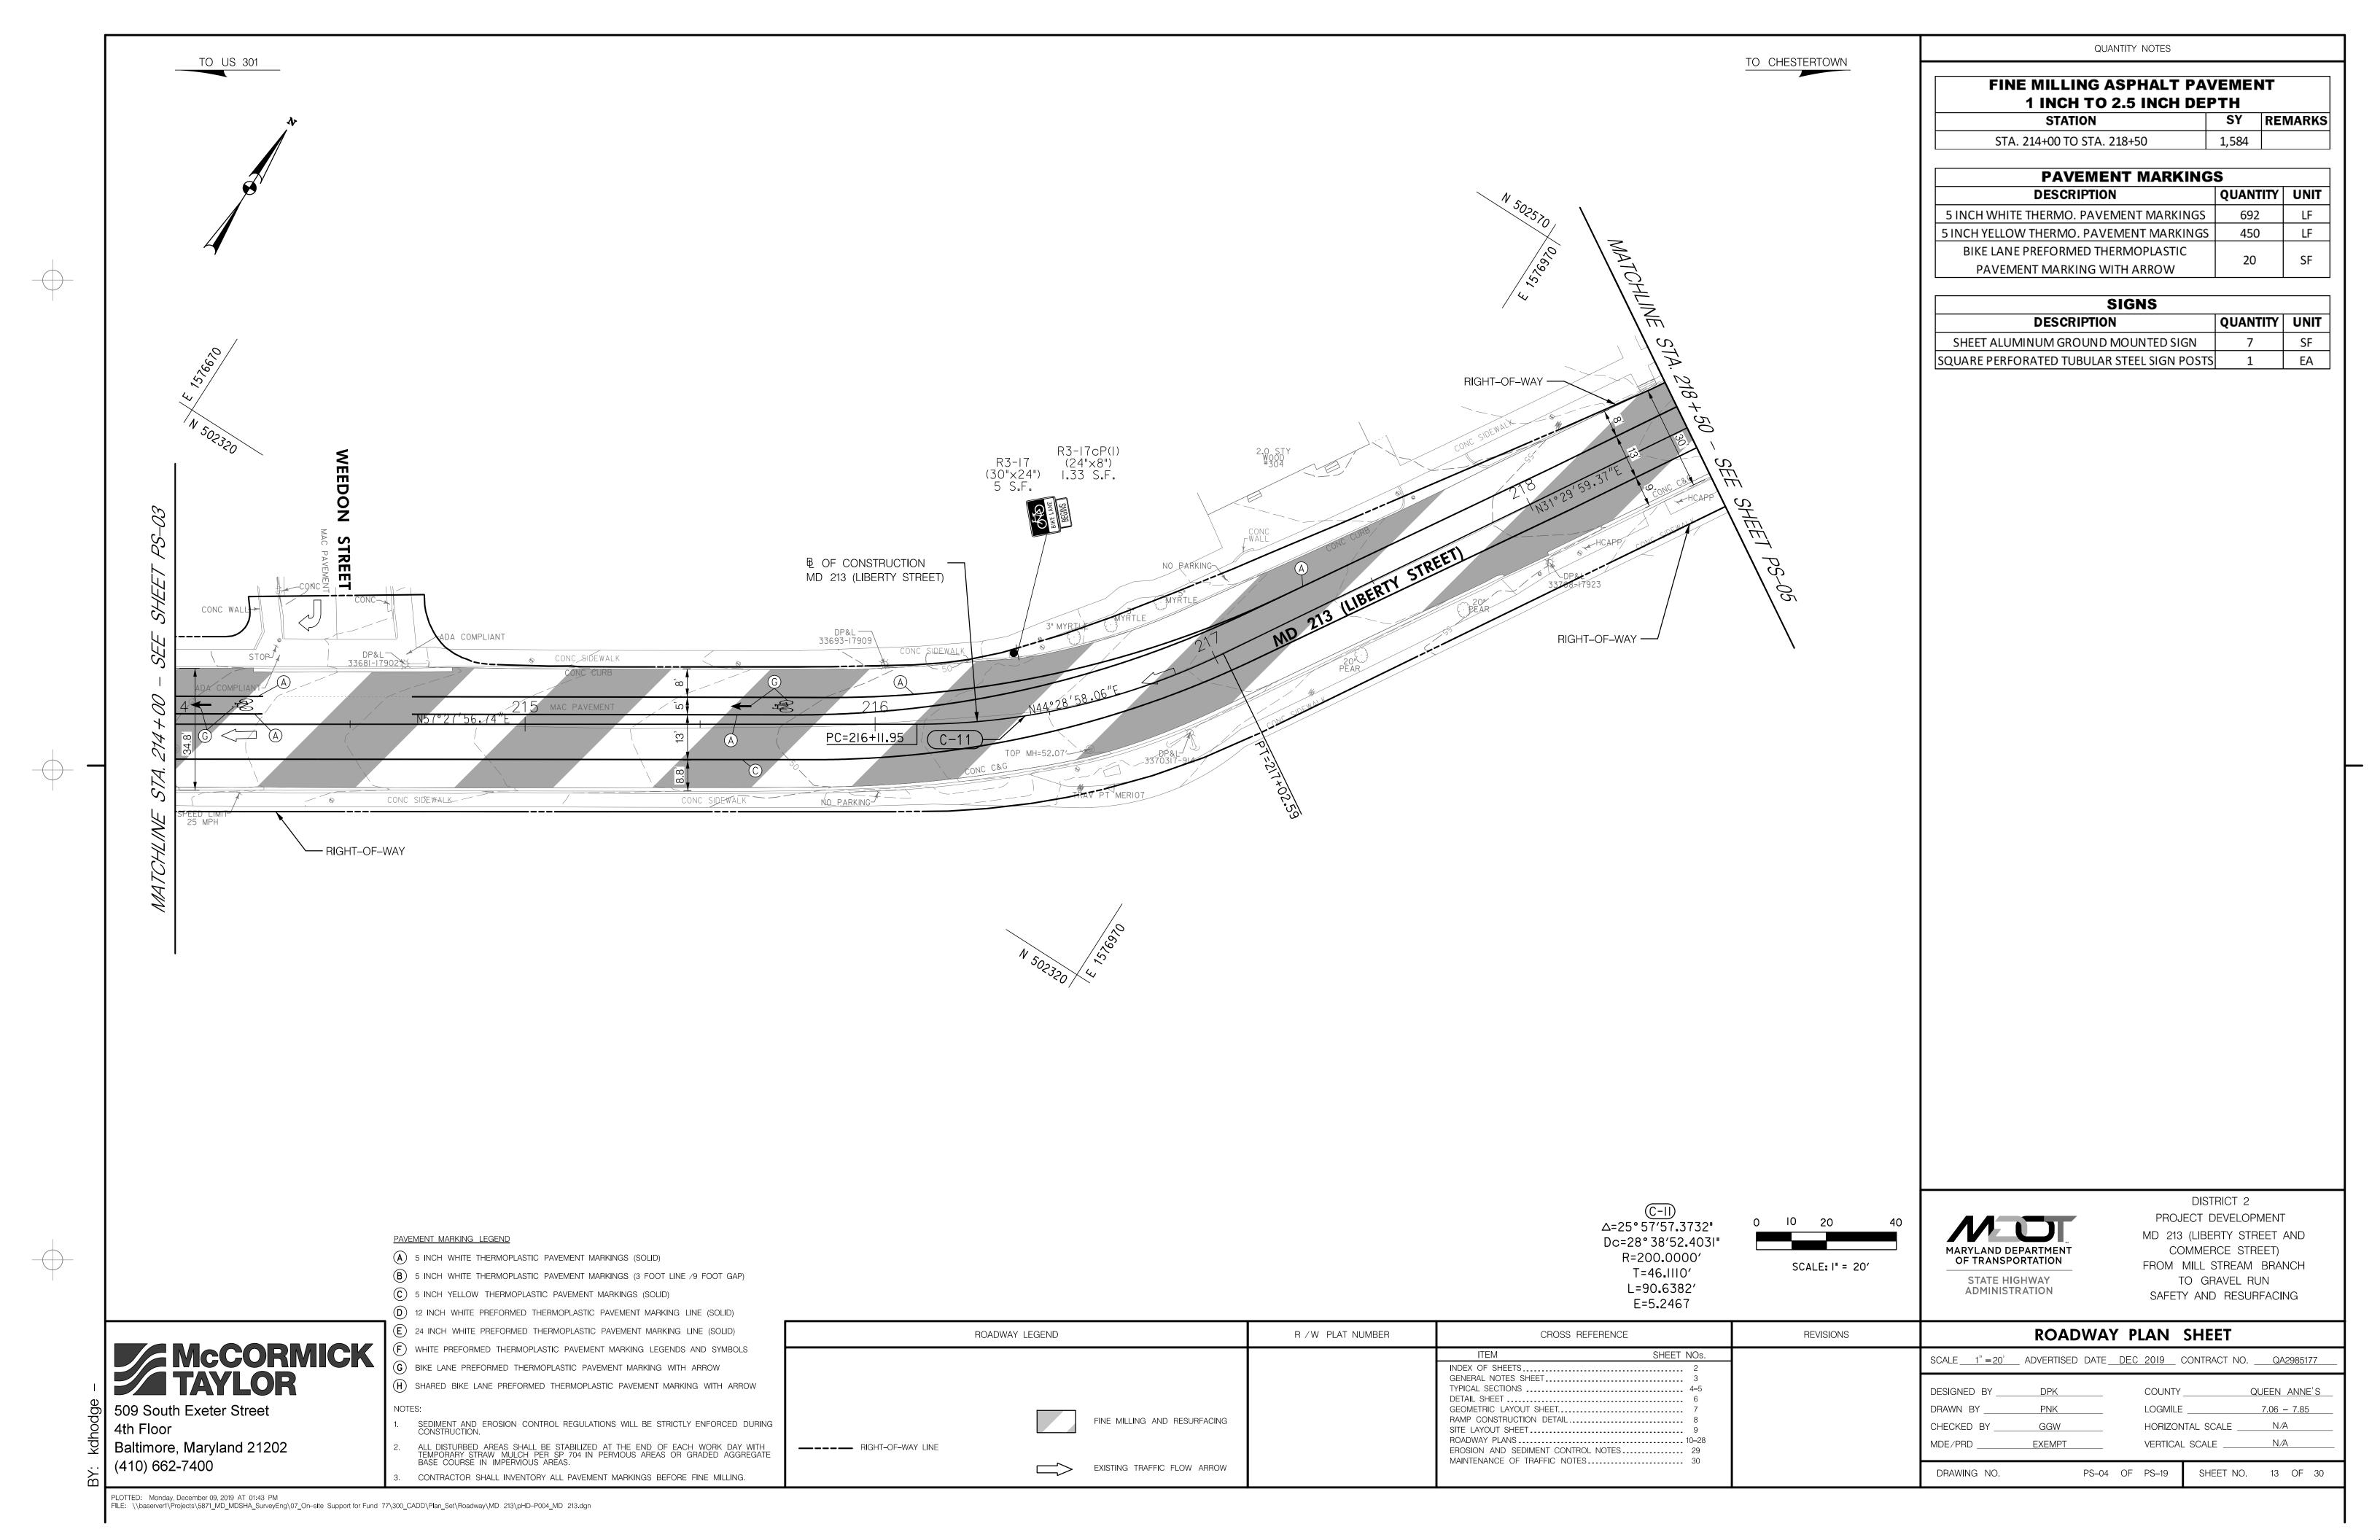

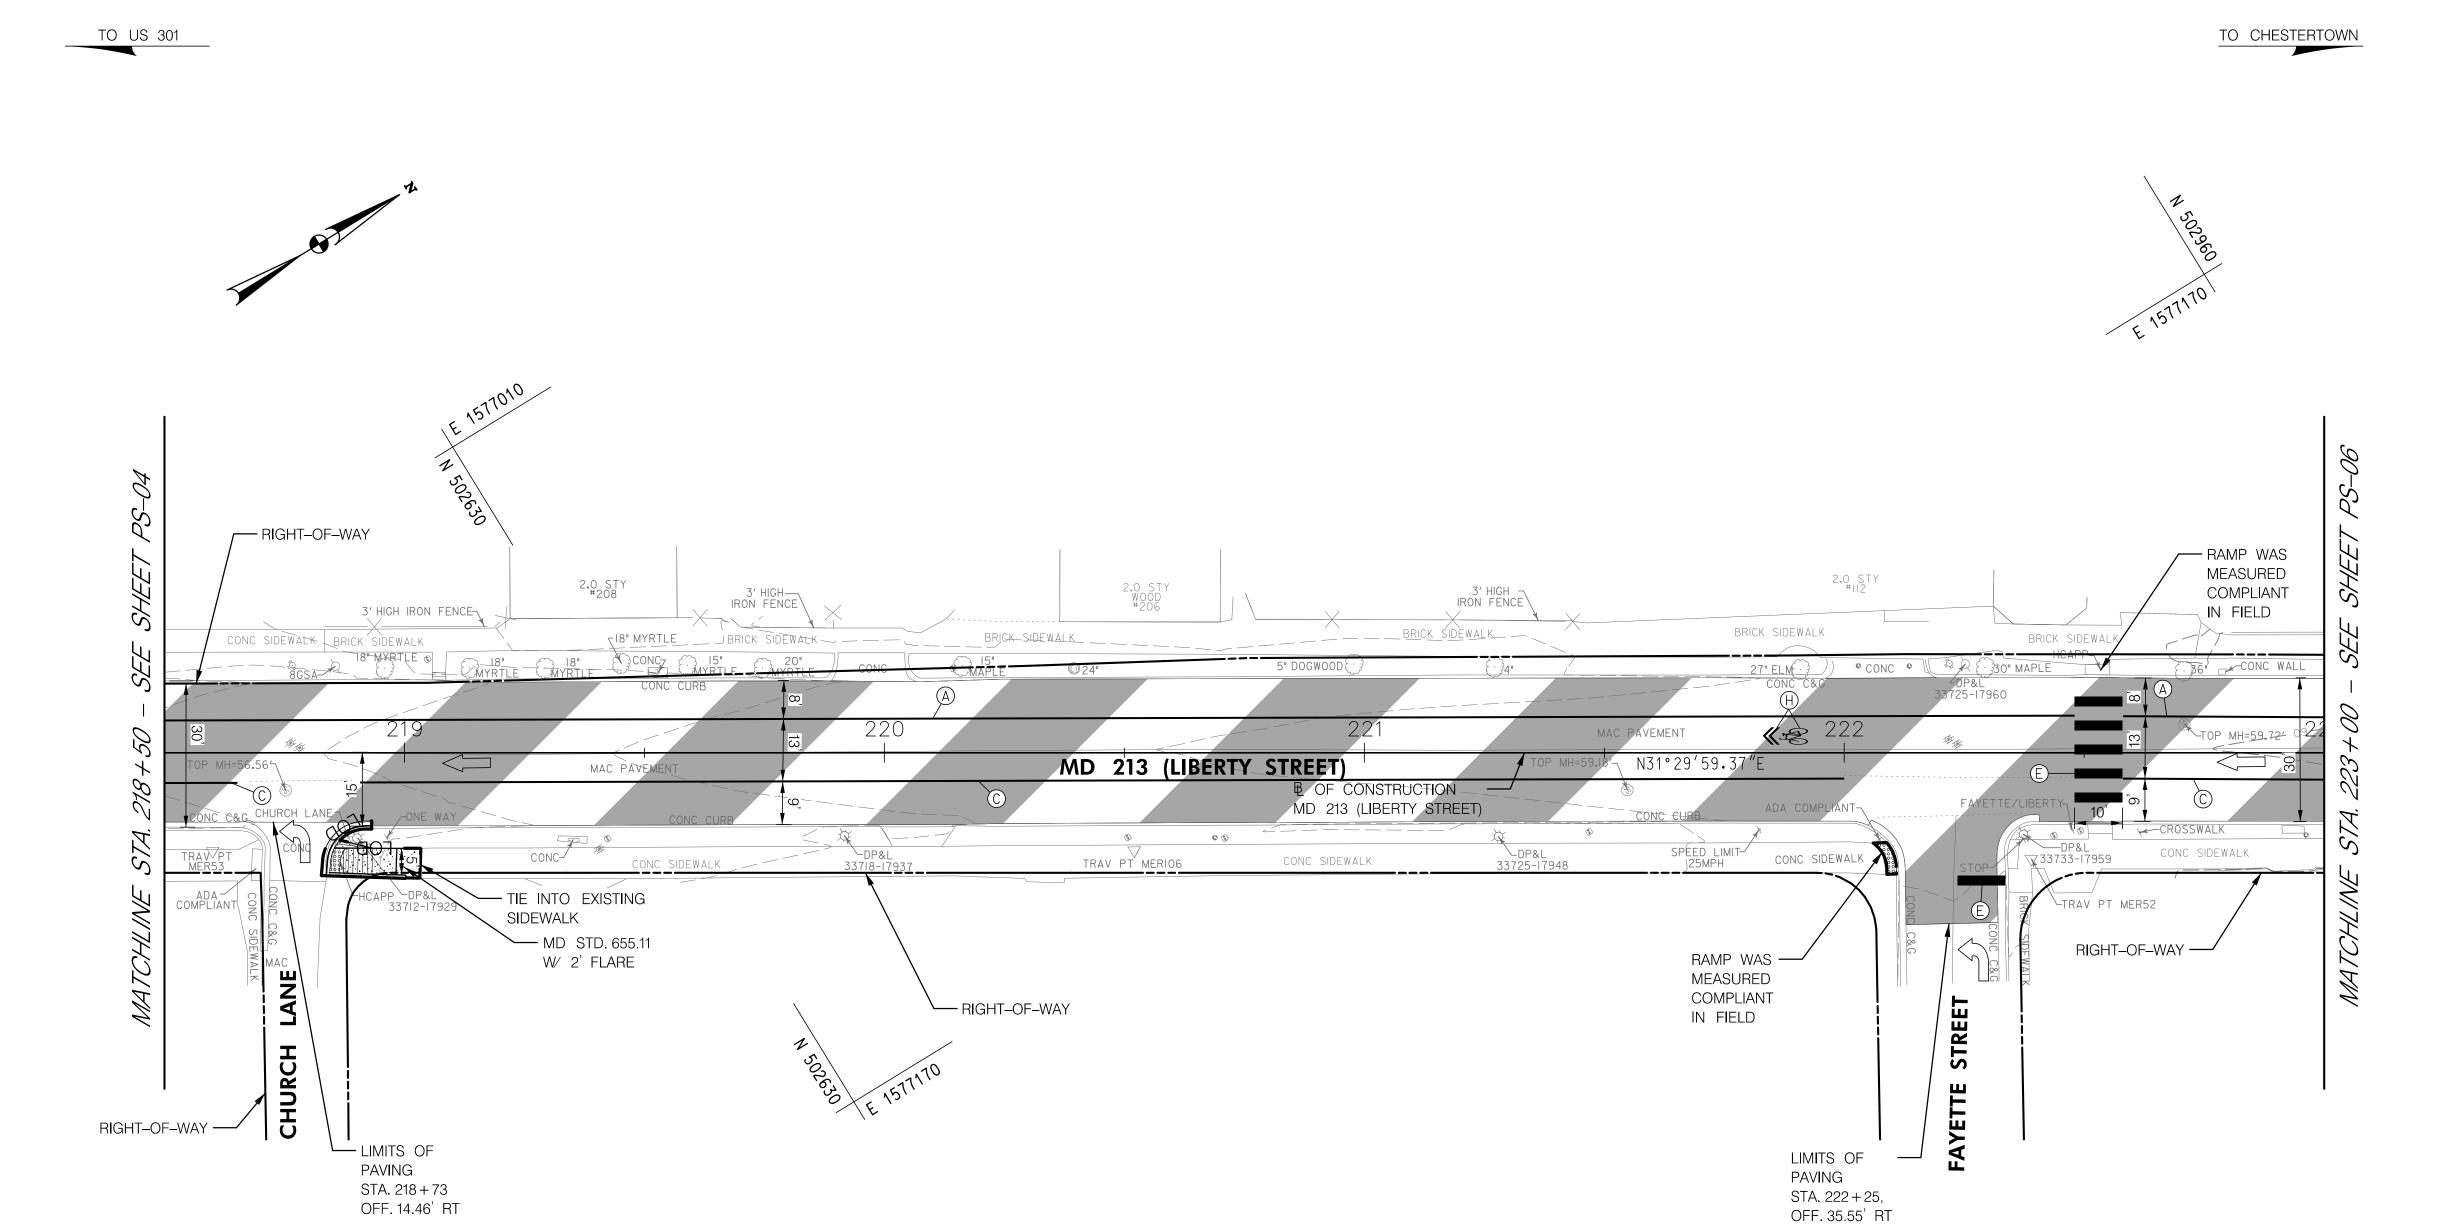

#### STANDARD TYPE A COMBINATION CURB **AND GUTTER 12 INCH GUTTER PAN 8 INCH MINIMUM DEPTH** LF REMARKS STATION STA. 218+84, 26' RT TO STA. 218+93, 15' RT 16

5 INCH CONCRETE SIDEWALK					
STATION	SF	REMARKS			
STA. 218+85, RT TO STA. 219+03, RT	109				

DETECTABLE WARNING SURFACE FOR CURB RAMPS				
STATION	SF	REMARKS		
STA. 218+86, 23' RT	11			
STA. 222+09, 22' RT	14			

FINE MILLING ASPHALT PAVEMENT 1 INCH TO 2.5 INCH DEPTH				
STATION	SY	REMARKS		
STA 218+50 TO STA. 223+00	1,538			

STANDARD TYPE A CURB 8 INCH X 16 INCH MINIMUM				
STATION	LF	REMARKS		
STA 218+84, 26' RT TO STA. 219+00, 26' RT	16			

PAVEMENT MARKINGS							
QUANTITY	UNIT						
440	LF						
368	LF						
60							
60	LF						
0	SE						
9	31						
	QUANTITY 440						

0 10 20 SCALE: I" = 20' MARYLAND DEPARTMENT OF TRANSPORTATION STATE HIGHWAY

**ADMINISTRATION** 

DISTRICT 2 PROJECT DEVELOPMENT MD 213 (LIBERTY STREET AND COMMERCE STREET) FROM MILL STREAM BRANCH TO GRAVEL RUN SAFETY AND RESURFACING

McCORMICK TAYLOR

509 South Exeter Street 4th Floor Baltimore, Maryland 21202 (410) 662-7400

PAVEMENT MARKING LEGEND (A) 5 INCH WHITE THERMOPLASTIC PAVEMENT MARKINGS (SOLID)

(B) 5 INCH WHITE THERMOPLASTIC PAVEMENT MARKINGS (3 FOOT LINE /9 FOOT GAP)

© 5 INCH YELLOW THERMOPLASTIC PAVEMENT MARKINGS (SOLID)

(D) 12 INCH WHITE PREFORMED THERMOPLASTIC PAVEMENT MARKING LINE (SOLID)

(E) 24 INCH WHITE PREFORMED THERMOPLASTIC PAVEMENT MARKING LINE (SOLID)


F) WHITE PREFORMED THERMOPLASTIC PAVEMENT MARKING LEGENDS AND SYMBOLS

6 BIKE LANE PREFORMED THERMOPLASTIC PAVEMENT MARKING WITH ARROW H SHARED BIKE LANE PREFORMED THERMOPLASTIC PAVEMENT MARKING WITH ARROW

SEDIMENT AND EROSION CONTROL REGULATIONS WILL BE STRICTLY ENFORCED DURING CONSTRUCTION.

ALL DISTURBED AREAS SHALL BE STABILIZED AT THE END OF EACH WORK DAY WITH TEMPORARY STRAW MULCH PER SP 704 IN PERVIOUS AREAS OR GRADED AGGREGATE BASE COURSE IN IMPERVIOUS AREAS. CONTRACTOR SHALL INVENTORY ALL PAVEMENT MARKINGS BEFORE FINE MILLING.

ROADWAY LEGEND	R /W PLAT NUMBER	CROSS REFERENCE	REVISIONS	ROADWAY PLAN SHEET
CONCRETE SIDEWALK		ITEM SHEET NOs.  INDEX OF SHEETS 2		SCALE 1" = 20' ADVERTISED DATE DEC 2019 CONTRACT NO. QA2985177
SIDEWALK RAMP  DETECTABLE WARNING SURFACE  RIGHT-OF-WAY LINE		GENERAL NOTES SHEET       3         TYPICAL SECTIONS       4-5         DETAIL SHEET       6         GEOMETRIC LAYOUT SHEET       7         RAMP CONSTRUCTION DETAIL       8         SITE LAYOUT SHEET       9         ROADWAY PLANS       10-28         EROSION AND SEDIMENT CONTROL NOTES       29         MAINTENANCE OF TRAFFIC NOTES       30		DESIGNED BY         DPK         COUNTY         QUEEN ANNE'S           DRAWN BY         PNK         LOGMILE         7.06 - 7.85           CHECKED BY         GGW         HORIZONTAL SCALE         N/A           MDE/PRD         EXEMPT         VERTICAL SCALE         N/A
- LOD - LIMIT OF DISTURBANCE EXISTING TRAFFIC FLOW ARROW				DRAWING NO. PS-05 OF PS-19 SHEET NO. 14 OF 30

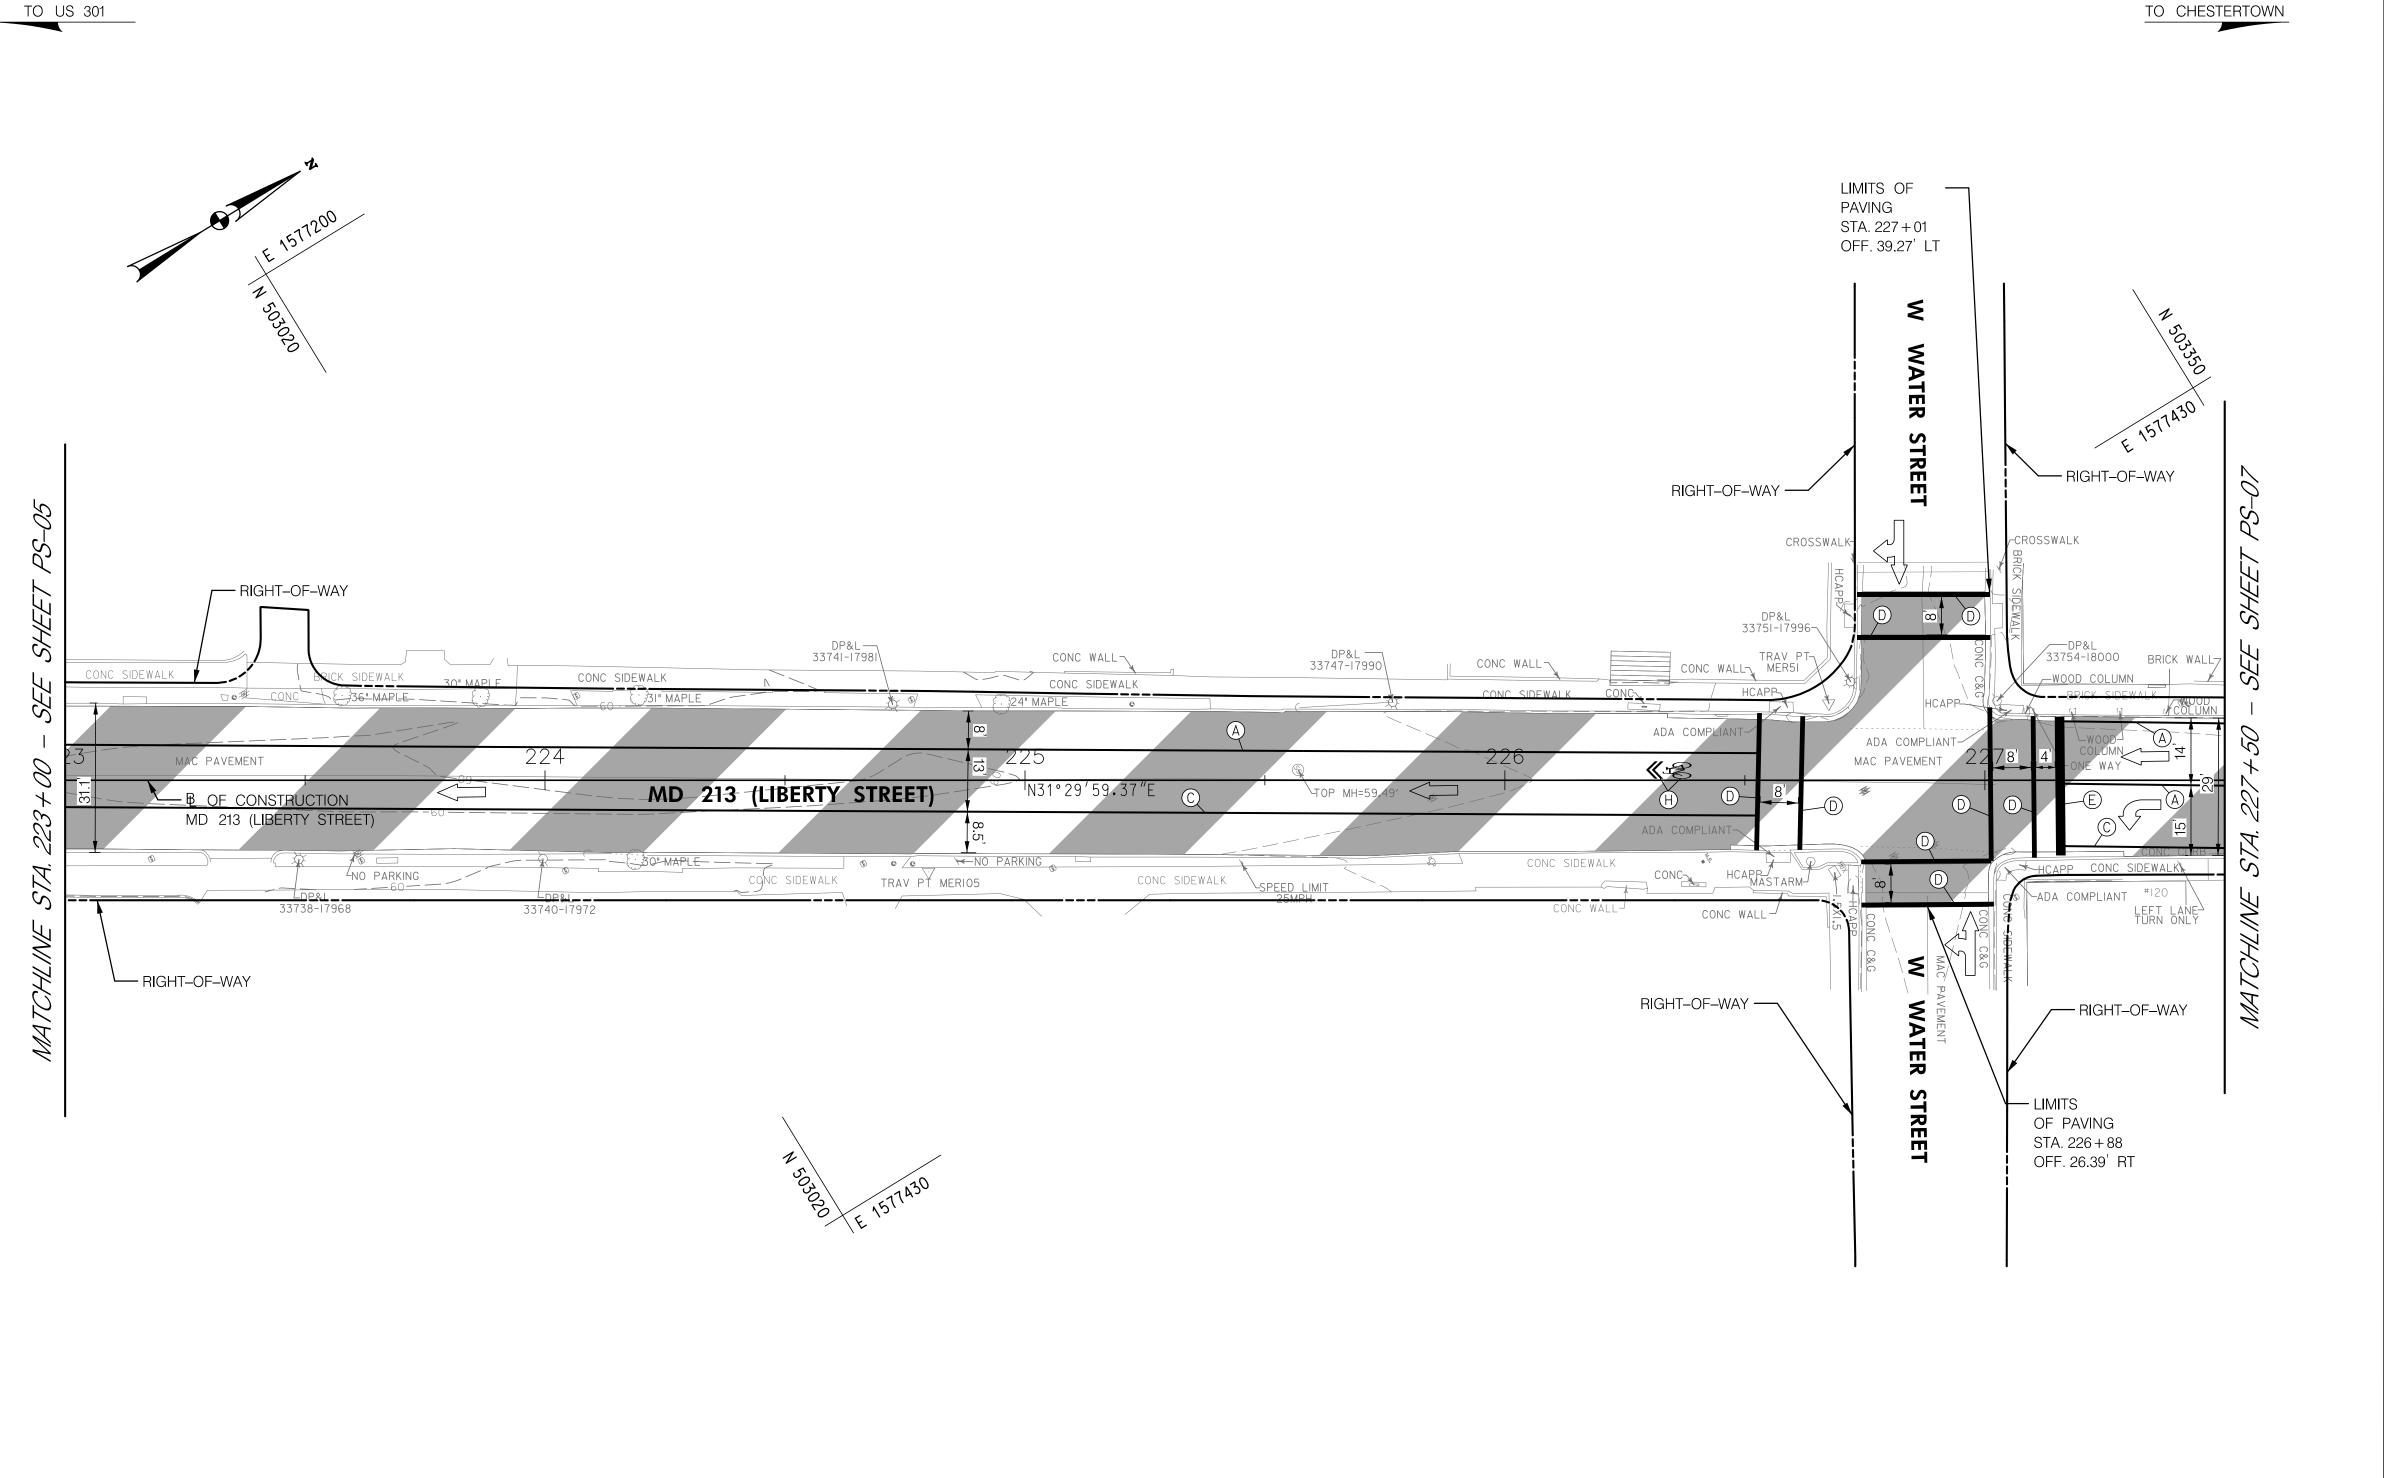

#### FINE MILLING ASPHALT PAVEMENT 1 INCH TO 2.5 INCH DEPTH STATION SY REMARKS 1,565 STA. 223+00 TO STA. 227+50

PAVEMENT MARKINGS						
DESCRIPTION	QUANTITY	UNIT				
5 INCH WHITE THERMO. PAVEMENT MARKINGS	421	LF				
5 INCH YELLOW THERMO. PAVEMENT MARKINGS	387	LF				
12 INCH WHITE PREFORMED THERMOPLASTIC	232	LF				
PAVEMENT MARKING LINE	232					
24 INCH WHITE PREFORMED THERMOPLASTIC	29	LF				
PAVEMENT MARKING LINE	29	LF				
SHARED BIKE LANE PREFORMED THERMOPLASTIC	0	SF				
PAVEMENT MARKING WITH ARROW	9	3F				

SCALE: I" = 20'

MARYLAND DEPARTMENT OF TRANSPORTATION STATE HIGHWAY

**ADMINISTRATION** 

DISTRICT 2 PROJECT DEVELOPMENT MD 213 (LIBERTY STREET AND COMMERCE STREET) FROM MILL STREAM BRANCH TO GRAVEL RUN SAFETY AND RESURFACING

MCCORMICK

F WHITE PREFORMED THERMOPLASTIC PAVEMENT MARKING LINE (SOLI E)

BIKE LANE PREFORMED THERMOPLASTIC PAVEMENT MARKING WITH ARROW

H SHARED BIKE LANE PREFORMED THERMOPLASTIC PAVEMENT MARKING WITH ARROW

H SHARED BIKE LANE PREFORMED THERMOPLASTIC PAVEMENT MARKING WITH A

509 South Exeter Street 4th Floor Baltimore, Maryland 21202 (410) 662-7400

PAVEMENT MARKING LEGEND (A) 5 INCH WHITE THERMOPLASTIC PAVEMENT MARKINGS (SOLID)

(B) 5 INCH WHITE THERMOPLASTIC PAVEMENT MARKINGS (3 FOOT LINE /9 FOOT GAP)

© 5 INCH YELLOW THERMOPLASTIC PAVEMENT MARKINGS (SOLID)

(D) 12 INCH WHITE PREFORMED THERMOPLASTIC PAVEMENT MARKING LINE (SOLID)

(E) 24 INCH WHITE PREFORMED THERMOPLASTIC PAVEMENT MARKING LINE (SOLID) F WHITE PREFORMED THERMOPLASTIC PAVEMENT MARKING LEGENDS AND SYMBOLS

(H) SHARED BIKE LANE PREFORMED THERMOPLASTIC PAVEMENT MARKING WITH ARROW

SEDIMENT AND EROSION CONTROL REGULATIONS WILL BE STRICTLY ENFORCED DURING CONSTRUCTION.

ALL DISTURBED AREAS SHALL BE STABILIZED AT THE END OF EACH WORK DAY WITH TEMPORARY STRAW MULCH PER SP 704 IN PERVIOUS AREAS OR GRADED AGGREGATE BASE COURSE IN IMPERVIOUS AREAS. CONTRACTOR SHALL INVENTORY ALL PAVEMENT MARKINGS BEFORE FINE MILLING.

ROADWAY LEGEND	R /W PLAT NUMBER	CROSS REFERENCE	REVISIONS	ROADWAY PLAN SHEET
		ITEM SHEET NOs.  INDEX OF SHEETS 2		SCALE 1" = 20' ADVERTISED DATE DEC 2019 CONTRACT NO. QA2985177
FINE MILLING AND RESURFACING  RIGHT-OF-WAY LINE  EXISTING TRAFFIC FLOW ARROW		GENERAL NOTES SHEET       3         TYPICAL SECTIONS       4–5         DETAIL SHEET       6         GEOMETRIC LAYOUT SHEET       7         RAMP CONSTRUCTION DETAIL       8         SITE LAYOUT SHEET       9         ROADWAY PLANS       10–28         EROSION AND SEDIMENT CONTROL NOTES       29         MAINTENANCE OF TRAFFIC NOTES       30		DESIGNED BY         DPK         COUNTY         QUEEN ANNE'S           DRAWN BY         PNK         LOGMILE         7.06 - 7.85           CHECKED BY         GGW         HORIZONTAL SCALE         N/A           MDE/PRD         EXEMPT         VERTICAL SCALE         N/A
				DRAWING NO. PS-06 OF PS-19 SHEET NO. 15 OF 30



1 INCH TO 2.5 INCH DEPTH SY REMARKS STATION STA. 227+50 TO STA. 232+00 1,840

#### STANDARD TYPE A COMBINATION CURB AND GUTTER 12 INCH GUTTER PAN 8 INCH MINIMUM DEPTH LF REMARKS STATION

STA. 229+85, 31' RT TO STA. 229+95, 39' RT **BRICK SIDEWALK** 

STATION

STA. 229+87, RT TO STA. 229+92, RT

STA. 229+93, 37' RT

15

25

10

SF REMARKS

#### DETECTABLE WARNING SURFACE **USING BRICK PAVERS** SF REMARKS STATION 10 STA. 229+89, 33' RT

#### 5 INCH CONCRETE SIDEWALK SF REMARKS STATION STA. 229+92, RT TO STA. 229+93, RT 2

PAVEMENT MARKINGS				
DESCRIPTION QUANTITY				
5 INCH WHITE THERMO. PAVEMENT MARKINGS	867	LF		
5 INCH YELLOW THERMO. PAVEMENT MARKINGS	257	LF		
12 INCH WHITE PREFORMED THERMOPLASTIC	333	ΙF		
PAVEMENT MARKING LINE	333	LF		
24 INCH WHITE PREFORMED THERMOPLASTIC	50	LF		
PAVEMENT MARKING LINE	30	LIT		
WHITE PREFORMED THERMOPLASTIC PAVEMENT	57	SF		
MARKING LEGENDS AND SYMBOLS	3/	31		
SHARED BIKE LANE PREFORMED THERMOPLASTIC	18	SF		
PAVEMENT MARKING WITH ARROW	10	31		

SIGNS			
DESCRIPTION	QUANTITY	UNIT	
SHEET ALUMINUM GROUND MOUNTED SIGN	7	SF	
SQUARE PERFORATED TUBULAR STEEL SIGN POSTS	1	EA	

LIMITS OF R4-11 PAVING (30"×30") 6.25 S.F. STA. 230 + 35 OFF. 43.93' LT MAY USE FILL LANE RIGHT-OF-WAY ADA COMPLIANT BEGIN LANE SHIFT — RAMP WAS -- END LANE SHIFT - RIGHT-OF-WAY ADA COMPLIANT -STA. 229 + 25 - RAMP WAS MEASURED STA. 228 + 25MEASURED COMPLIANT - B OF CONSTRUCTION COMPLIANT IN FIELD MD 213 (LIBERTY STREET) IN FIELD CONC SIDEWALK CONC SIDEWALK NC SIDEWALK **33758-18007** MD 213 (LIBERTY STREET) MD STD. 655.40 BRICK SIDEWALK DP&L-3376218006 BASEMENT ENTRANCE-NIA TCHLINE RIGHT-OF-WAY ----— MD STD. 655.40 RIGHT-OF-WAY - RAMP WAS 12" MAPLE BRICK SIDEWALK MEASURED TIE INTO EXISTING SIDEWALK — COMPLIANT ADA COMPLIANT-IN FIELD TIE INTO EXISTING SIDEWALK — RAMP WAS — MEASURED COMPLIANT IN FIELD - LIMITS OF PAVING STA. 230 + 21 OFF. 42.40' RT

PAVEMENT MARKING LEGEND

(A) 5 INCH WHITE THERMOPLASTIC PAVEMENT MARKINGS (SOLID)

(B) 5 INCH WHITE THERMOPLASTIC PAVEMENT MARKINGS (3 FOOT LINE /9 FOOT GAP)

(C) 5 INCH YELLOW THERMOPLASTIC PAVEMENT MARKINGS (SOLID)

(D) 12 INCH WHITE PREFORMED THERMOPLASTIC PAVEMENT MARKING LINE (SOLID)

(E) 24 INCH WHITE PREFORMED THERMOPLASTIC PAVEMENT MARKING LINE (SOLID)

F) WHITE PREFORMED THERMOPLASTIC PAVEMENT MARKING LEGENDS AND SYMBOLS G BIKE LANE PREFORMED THERMOPLASTIC PAVEMENT MARKING WITH ARROW (H) SHARED BIKE LANE PREFORMED THERMOPLASTIC PAVEMENT MARKING WITH ARROW

SEDIMENT AND EROSION CONTROL REGULATIONS WILL BE STRICTLY ENFORCED DURING CONSTRUCTION.

ALL DISTURBED AREAS SHALL BE STABILIZED AT THE END OF EACH WORK DAY WITH TEMPORARY STRAW MULCH PER SP 704 IN PERVIOUS AREAS OR GRADED AGGREGATE BASE COURSE IN IMPERVIOUS AREAS.

CONTRACTOR SHALL INVENTORY ALL PAVEMENT MARKINGS BEFORE FINE MILLING.

FINE MILLING AND RESURFACING DETECTABLE WARNING SURFACE RIGHT-OF-WAY LINE BRICK SIDEWALK EXISTING TRAFFIC FLOW ARROW - LOD - LIMIT OF DISTURBANCE

ROADWAY LEGEND

ITEM SHEET NOs. INDEX OF SHEETS .. GENERAL NOTES SHEET. TYPICAL SECTIONS . DETAIL SHEET. GEOMETRIC LAYOUT SHEET.. RAMP CONSTRUCTION DETAIL. SITE LAYOUT SHEET .. ROADWAY PLANS .. EROSION AND SEDIMENT CONTROL NOTES. MAINTENANCE OF TRAFFIC NOTES..

CROSS REFERENCE

R / W PLAT NUMBER

MARYLAND DEPARTMENT OF TRANSPORTATION STATE HIGHWAY

DRAWING NO.

**ADMINISTRATION** 

SCALE: I" = 20'

REVISIONS

DISTRICT 2 PROJECT DEVELOPMENT MD 213 (LIBERTY STREET AND COMMERCE STREET) FROM MILL STREAM BRANCH TO GRAVEL RUN SAFETY AND RESURFACING

SHEET NO. 16 OF 30

SCALE <u>1" = 20'</u> ADVERTISED DATE <u>DEC 2019</u> CONTRACT NO. <u>QA2985177</u> DESIGNED BY COUNTY \_ QUEEN ANNE'S DRAWN BY LOGMILE 7.06 - 7.85 CHECKED BY GGW HORIZONTAL SCALE \_ MDE/PRD \_ VERTICAL SCALE


PS-07 OF PS-19

**ROADWAY PLAN SHEET** 

McCORMICK TAYLOR 509 South Exeter Street

4th Floor Baltimore, Maryland 21202 (410) 662-7400

PLOTTED: Monday, December 09, 2019 AT 01:44 PM FILE: \\baserver1\Projects\5871\_MD\_MDSHA\_SurveyEng\07\_On-site Support for Fund 77\300\_CADD\Plan\_Set\Roadway\MD 213\pHD-P007\_MD 213.dgn

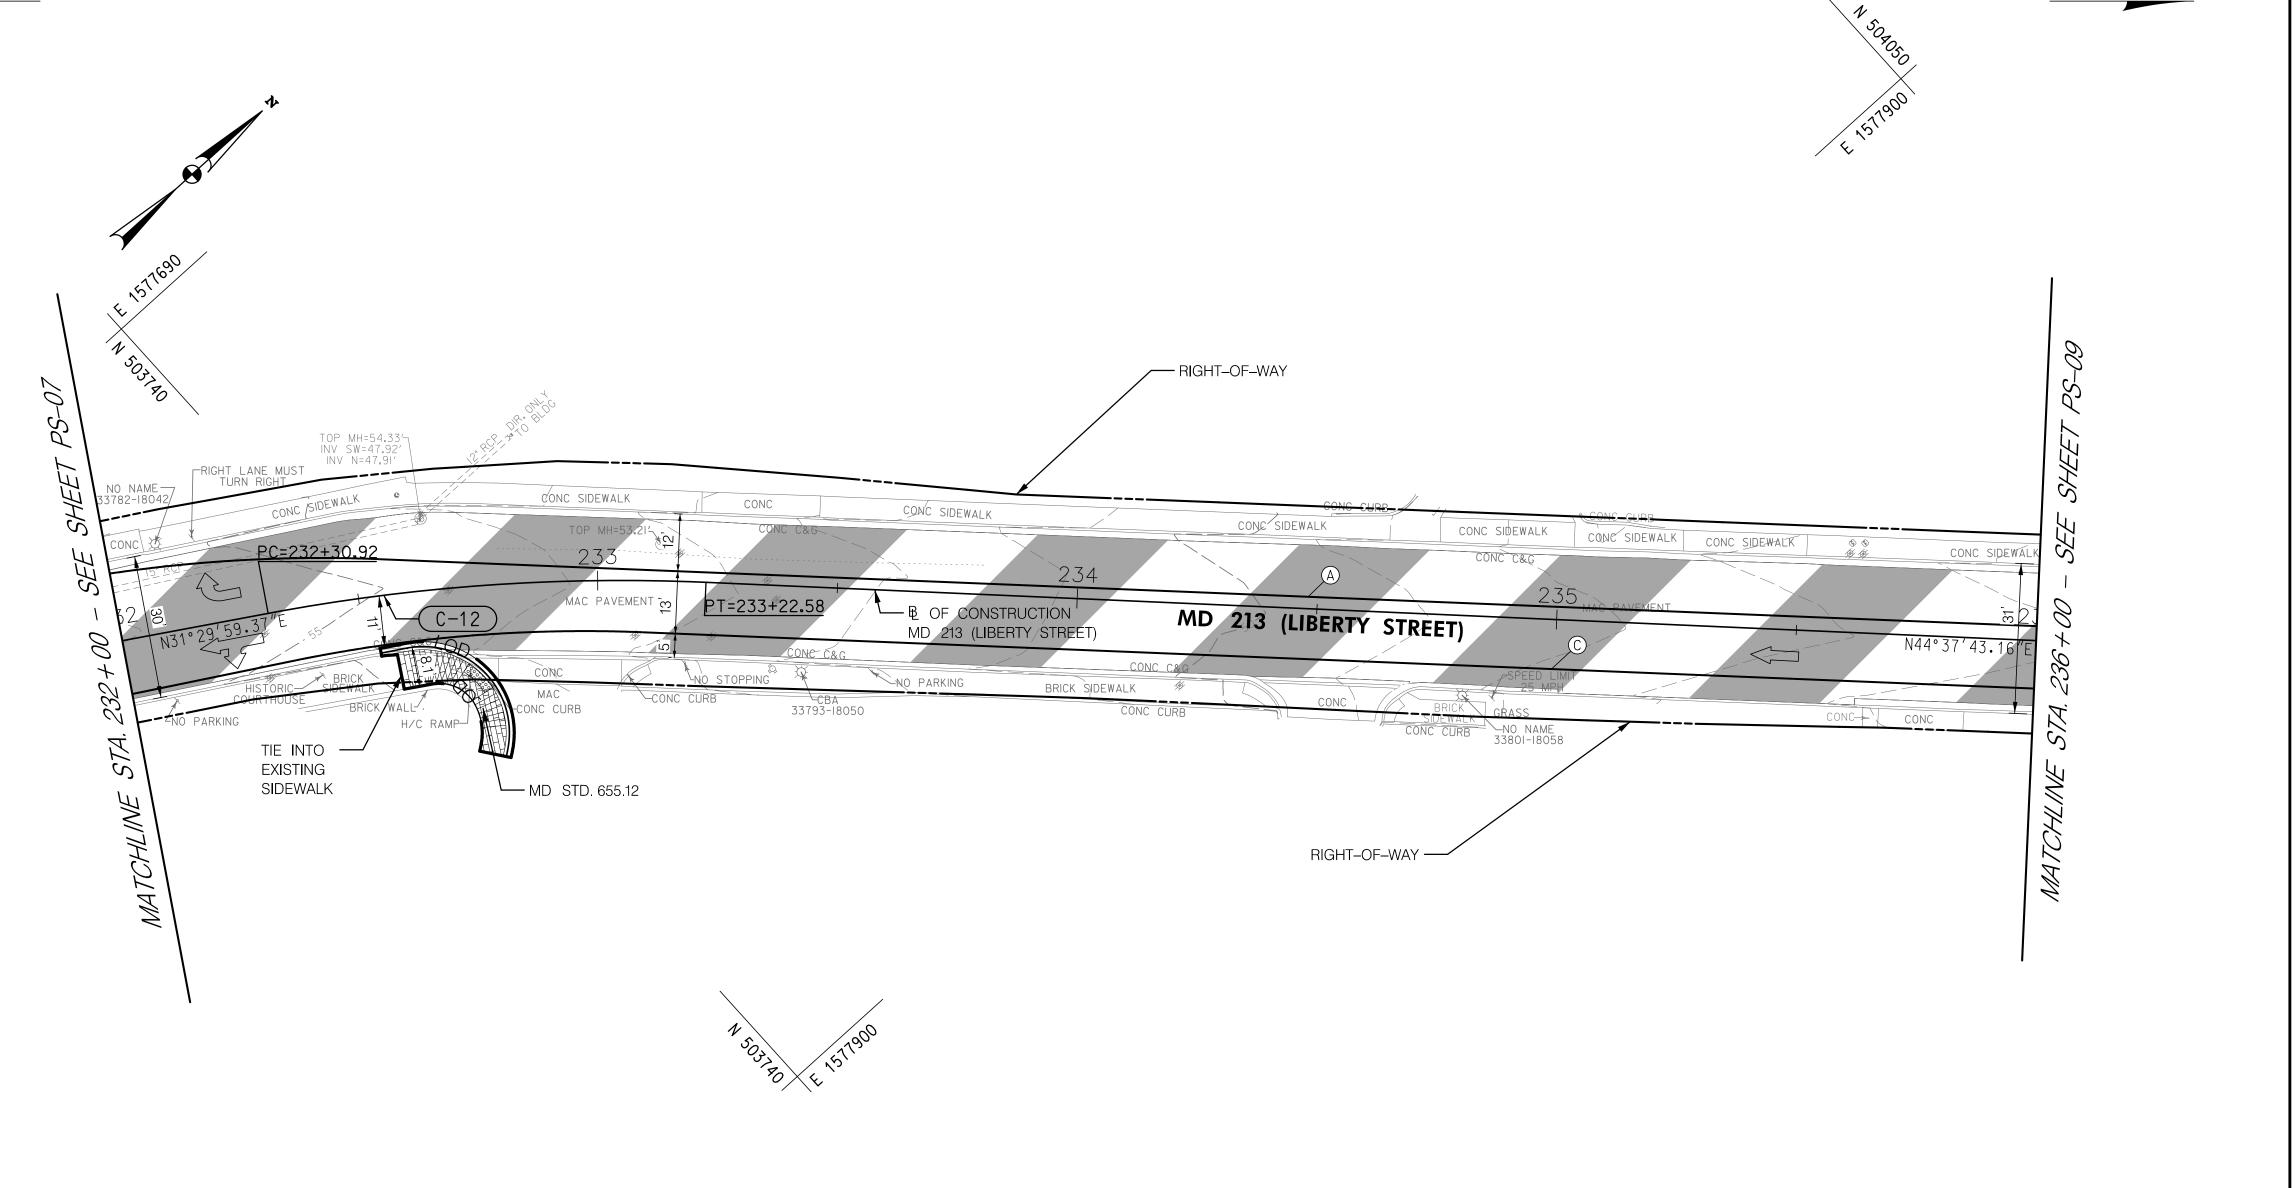

#### STANDARD TYPE A COMBINATION CURB **AND GUTTER 12 INCH GUTTER PAN 8 INCH MINIMUM DEPTH** LF REMARKS STATION STA. 232+53, 12' RT TO STA. 232+79, 36' RT 42

BRICK SIDEWALK	, L	
STATION	SF	REMARKS
STA. 232+57. RT TO STA. 232+78. RT	173	

DETECTABLE WARNING S		E
USING BRICK PAVERS STATION SF REMARK		
STA. 232+74, 19' RT	13	

FINE MILLING ASPHALT PAVEMENT				
1 INCH TO 2.5 INCH DEPTH				
STATION	SY	REMARKS		
STA 232+00 TO STA. 236+00	1,237			

REMOVAL OF EXISTING SIDEWALK			
STATION	CY	REMARKS	
STA 232+54, RT TO STA. 232+57, RT	1		

### **PAVEMENT MARKINGS**

ı	DESCRIPTION	QUANTITY	UNIT
ı	5 INCH WHITE THERMO. PAVEMENT MARKINGS	400	LF
ı	5 INCH YELLOW THERMO. PAVEMENT MARKINGS	400	LF

PAVEMENT MARKING LEGEND

(A) 5 INCH WHITE THERMOPLASTIC PAVEMENT MARKINGS (SOLID)

(B) 5 INCH WHITE THERMOPLASTIC PAVEMENT MARKINGS (3 FOOT LINE /9 FOOT GAP) © 5 INCH YELLOW THERMOPLASTIC PAVEMENT MARKINGS (SOLID)

(D) 12 INCH WHITE PREFORMED THERMOPLASTIC PAVEMENT MARKING LINE (SOLID)

(E) 24 INCH WHITE PREFORMED THERMOPLASTIC PAVEMENT MARKING LINE (SOLID)

F) WHITE PREFORMED THERMOPLASTIC PAVEMENT MARKING LEGENDS AND SYMBOLS


6 BIKE LANE PREFORMED THERMOPLASTIC PAVEMENT MARKING WITH ARROW H SHARED BIKE LANE PREFORMED THERMOPLASTIC PAVEMENT MARKING WITH ARROW

SEDIMENT AND EROSION CONTROL REGULATIONS WILL BE STRICTLY ENFORCED DURING CONSTRUCTION.

CONTRACTOR SHALL INVENTORY ALL PAVEMENT MARKINGS BEFORE FINE MILLING.

ALL DISTURBED AREAS SHALL BE STABILIZED AT THE END OF EACH WORK DAY WITH TEMPORARY STRAW MULCH PER SP 704 IN PERVIOUS AREAS OR GRADED AGGREGATE BASE COURSE IN IMPERVIOUS AREAS.

 $\Delta = 13^{\circ} 07'43.7877"$ Dc=14°19′26.2016" R=400.0000′ T=46.0298' L=91**.**6565′ E=2.6397

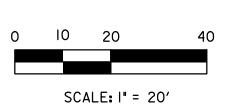

TO CHESTERTOWN

MARYLAND DEPARTMENT OF TRANSPORTATION

STATE HIGHWAY **ADMINISTRATION** 


DISTRICT 2 PROJECT DEVELOPMENT MD 213 (LIBERTY STREET AND COMMERCE STREET) FROM MILL STREAM BRANCH TO GRAVEL RUN SAFETY AND RESURFACING



TO US 301

509 South Exeter Street 4th Floor Baltimore, Maryland 21202 (410) 662-7400

**ROADWAY PLAN SHEET** R / W PLAT NUMBER ROADWAY LEGEND CROSS REFERENCE REVISIONS ITEM SHEET NOs. SCALE <u>1" = 20'</u> ADVERTISED DATE <u>DEC 2019</u> CONTRACT NO. <u>QA2985177</u> PAVEMENT REMOVAL INDEX OF SHEETS .. GENERAL NOTES SHEET. TYPICAL SECTIONS . COUNTY \_ DESIGNED BY \_ QUEEN ANNE'S SIDEWALK RAMP DETAIL SHEET. LOGMILE GEOMETRIC LAYOUT SHEET.. DRAWN BY 7.06 - 7.85 RAMP CONSTRUCTION DETAIL. DETECTABLE WARNING SURFACE FINE MILLING AND RESURFACING HORIZONTAL SCALE \_ CHECKED BY \_ GGW SITE LAYOUT SHEET .. ROADWAY PLANS ... MDE/PRD \_ EXEMPT VERTICAL SCALE BRICK SIDEWALK EROSION AND SEDIMENT CONTROL NOTES. MAINTENANCE OF TRAFFIC NOTES .. - LOD - LIMIT OF DISTURBANCE EXISTING TRAFFIC FLOW ARROW SHEET NO. 17 OF 30 DRAWING NO. PS-08 OF PS-19

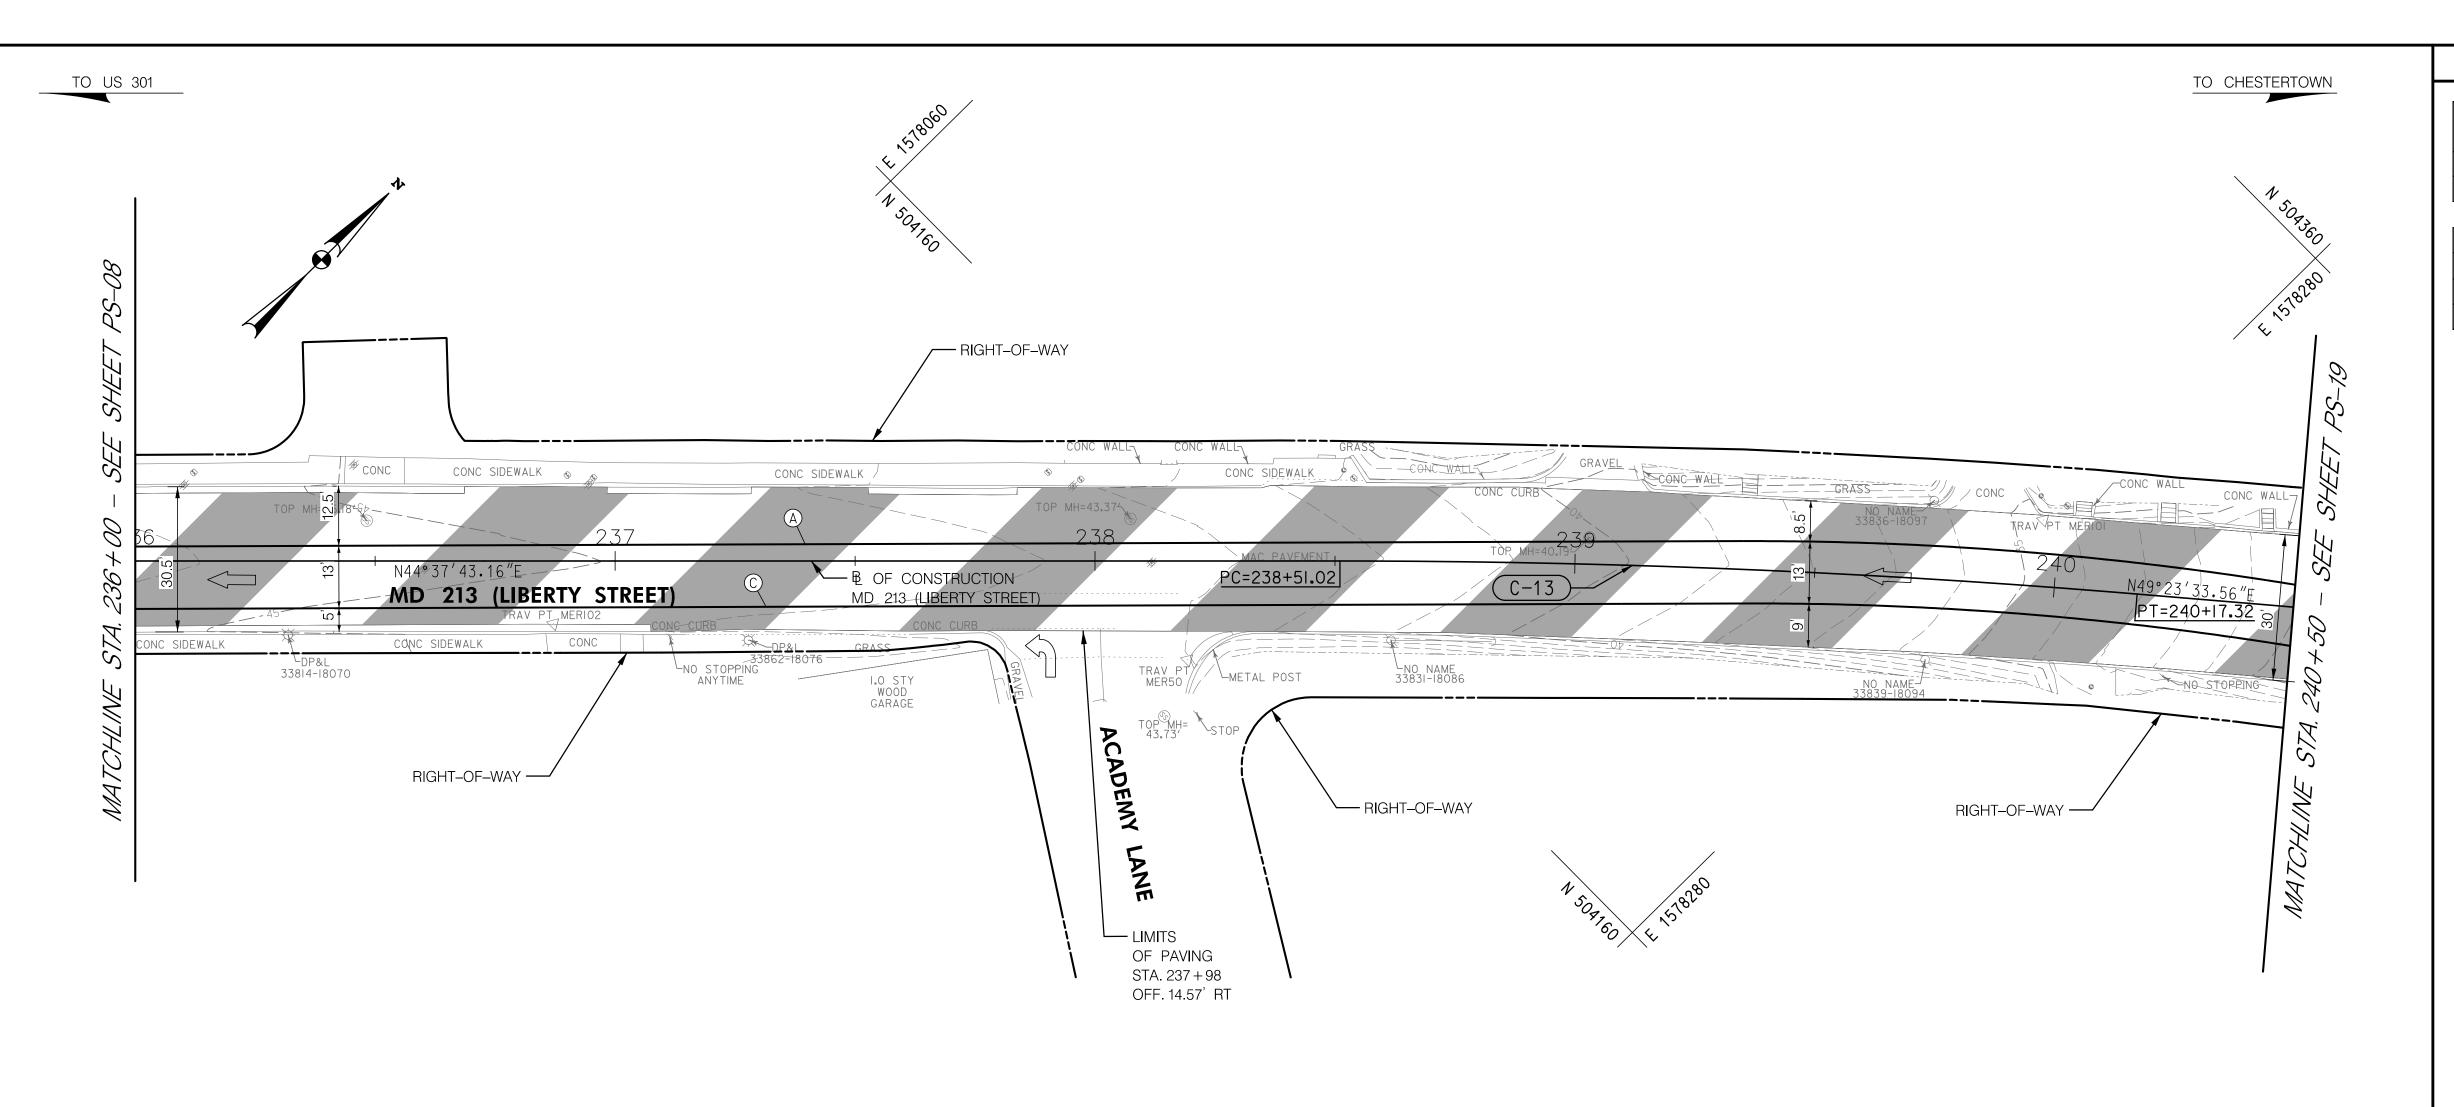

#### FINE MILLING ASPHALT PAVEMENT 1 INCH TO 2.5 INCH DEPTH SY REMARKS STATION STA. 236+00 TO STA. 240+50 1,471

PAVEMENT MARKINGS				
DESCRIPTION	QUANTITY	UNIT		
5 INCH WHITE THERMO. PAVEMENT MARKINGS	450	LF		
5 INCH YELLOW THERMO. PAVEMENT MARKINGS	450	LF		

PAVEMENT MARKING LEGEND

(A) 5 INCH WHITE THERMOPLASTIC PAVEMENT MARKINGS (SOLID)

(B) 5 INCH WHITE THERMOPLASTIC PAVEMENT MARKINGS (3 FOOT LINE /9 FOOT GAP)

© 5 INCH YELLOW THERMOPLASTIC PAVEMENT MARKINGS (SOLID)

(D) 12 INCH WHITE PREFORMED THERMOPLASTIC PAVEMENT MARKING LINE (SOLID)

(E) 24 INCH WHITE PREFORMED THERMOPLASTIC PAVEMENT MARKING LINE (SOLID)

F) WHITE PREFORMED THERMOPLASTIC PAVEMENT MARKING LEGENDS AND SYMBOLS


6 BIKE LANE PREFORMED THERMOPLASTIC PAVEMENT MARKING WITH ARROW (H) SHARED BIKE LANE PREFORMED THERMOPLASTIC PAVEMENT MARKING WITH ARROW

SEDIMENT AND EROSION CONTROL REGULATIONS WILL BE STRICTLY ENFORCED DURING CONSTRUCTION.

ALL DISTURBED AREAS SHALL BE STABILIZED AT THE END OF EACH WORK DAY WITH TEMPORARY STRAW MULCH PER SP 704 IN PERVIOUS AREAS OR GRADED AGGREGATE BASE COURSE IN IMPERVIOUS AREAS. CONTRACTOR SHALL INVENTORY ALL PAVEMENT MARKINGS BEFORE FINE MILLING.

 $\triangle = 4^{\circ} 45'50.4005"$ Dc=2°51′53.2403" R=2000.0000′ T=83**.**1954′ L=166.2950'


E=1.7296

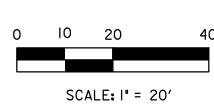

MARYLAND DEPARTMENT OF TRANSPORTATION


> STATE HIGHWAY **ADMINISTRATION**

DISTRICT 2 PROJECT DEVELOPMENT MD 213 (LIBERTY STREET AND COMMERCE STREET) FROM MILL STREAM BRANCH TO GRAVEL RUN SAFETY AND RESURFACING

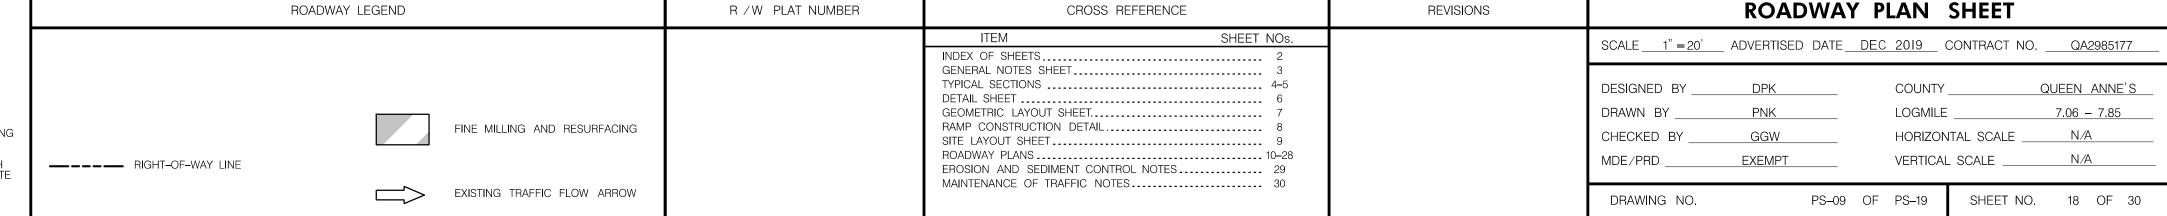

McCORMICK TAYLOR 509 South Exeter Street 4th Floor Baltimore, Maryland 21202 (410) 662-7400

PLOTTED: Monday, December 09, 2019 AT 01:44 PM
FILE: \\baserver1\Projects\5871\_MD\_MDSHA\_SurveyEng\07\_On-site Support for Fund 77\300\_CADD\Plan\_Set\Roadway\MD 213\pHD-P009\_MD 213.dgn

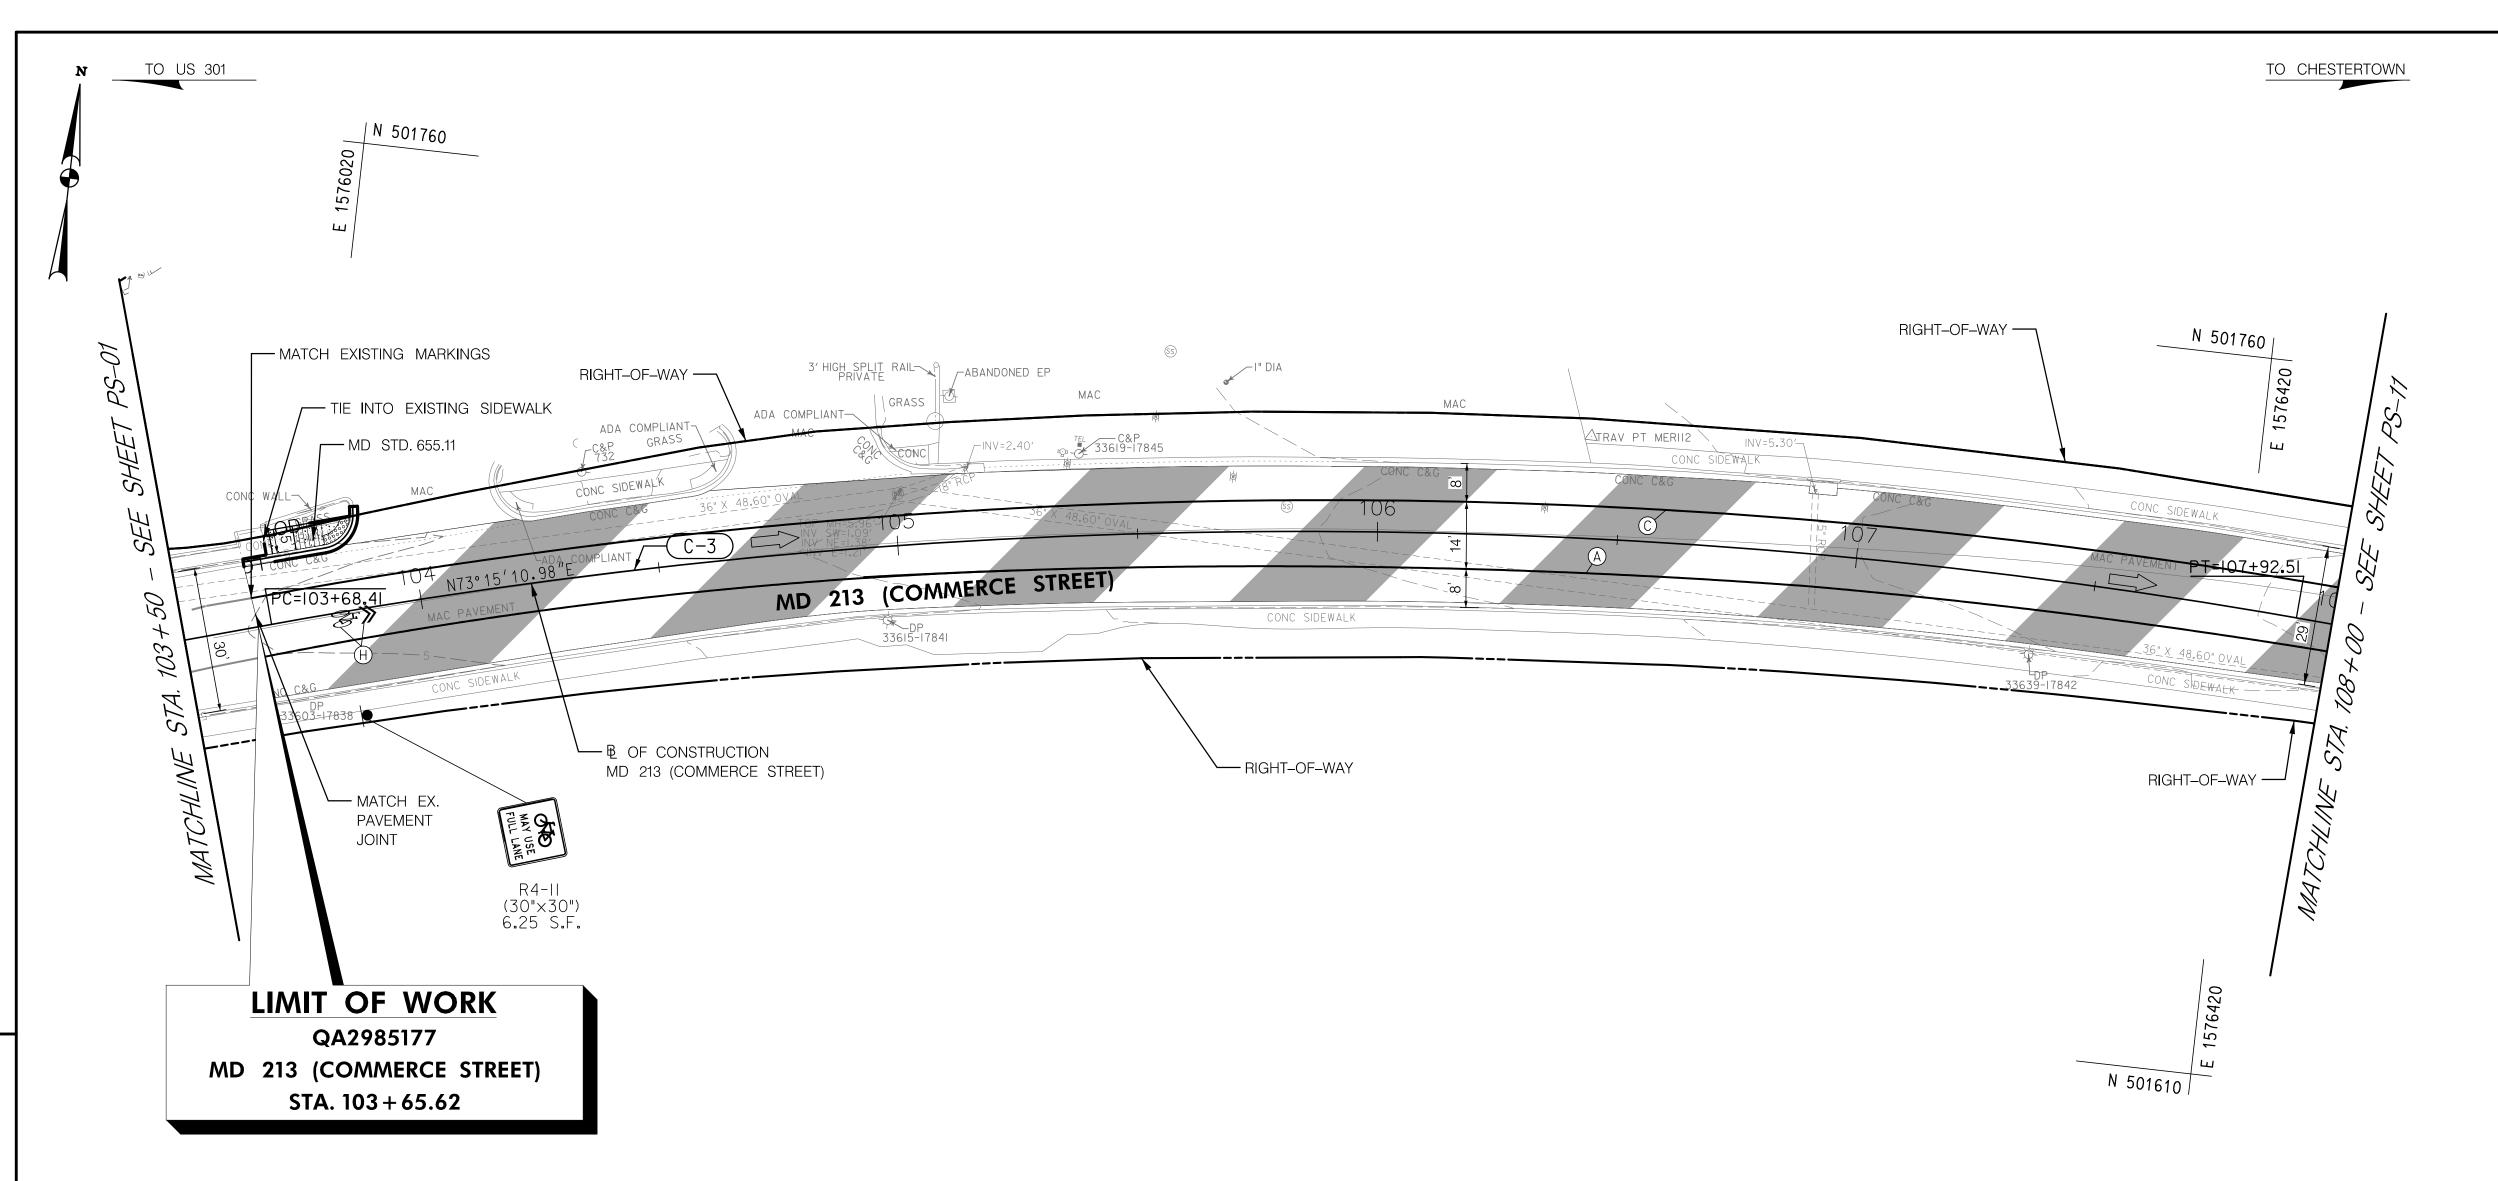

FINE MILLING ASPHALT PAVEMENT 1 INCH TO 2.5 INCH DEPTH		
STATION	SY	REMARKS
STA. 103+65 TO STA. 108+00	1,350	

#### STANDARD TYPE A COMBINATION CURB AND GUTTER 12 INCH GUTTER PAN **8 INCH MINIMUM DEPTH** LF REMARKS STATION

STA. 103+65, 14' LT TO STA. 103+89, 21' LT

5 INCH CONCRETE SIDEWALK SF REMARKS STATION STA. 103+70, LT TO STA. 103+88, LT 84

DETECTABLE WARNING SURFACE FOR CURB RAMPS		
STATION	SF	REMARKS
STA. 103+85, 17' LT	14	

29

PAVEMENT MARKINGS			
DESCRIPTION	QUANTITY	UNIT	
5 INCH WHITE THERMO. PAVEMENT MARKINGS	435	LF	
5 INCH YELLOW THERMO. PAVEMENT MARKINGS	435	LF	
SHARED BIKE LANE PREFORMED THERMOPLASTIC	9	SF	
PAVEMENT MARKING WITH ARROW	9	31	

SIGNS			
DESCRIPTION	QUANTITY	UNIT	
SHEET ALUMINUM GROUND MOUNTED SIGN	7	SF	
SQUARE PERFORATED TUBULAR STEEL SIGN POSTS	1	EA	

PAVEMENT MARKING LEGEND

(A) 5 INCH WHITE THERMOPLASTIC PAVEMENT MARKINGS (SOLID)

(B) 5 INCH WHITE THERMOPLASTIC PAVEMENT MARKINGS (3 FOOT LINE /9 FOOT GAP)

(C) 5 INCH YELLOW THERMOPLASTIC PAVEMENT MARKINGS (SOLID)

(D) 12 INCH WHITE PREFORMED THERMOPLASTIC PAVEMENT MARKING LINE (SOLID)

(E) 24 INCH WHITE PREFORMED THERMOPLASTIC PAVEMENT MARKING LINE (SOLID)

F) WHITE PREFORMED THERMOPLASTIC PAVEMENT MARKING LEGENDS AND SYMBOLS


G BIKE LANE PREFORMED THERMOPLASTIC PAVEMENT MARKING WITH ARROW (H) SHARED BIKE LANE PREFORMED THERMOPLASTIC PAVEMENT MARKING WITH ARROW

SEDIMENT AND EROSION CONTROL REGULATIONS WILL BE STRICTLY ENFORCED DURING CONSTRUCTION.

ALL DISTURBED AREAS SHALL BE STABILIZED AT THE END OF EACH WORK DAY WITH TEMPORARY STRAW MULCH PER SP 704 IN PERVIOUS AREAS OR GRADED AGGREGATE BASE COURSE IN IMPERVIOUS AREAS. CONTRACTOR SHALL INVENTORY ALL PAVEMENT MARKINGS BEFORE FINE MILLING.

 $\Delta$ =20°14′56.6755" Dc=4° 46′28.7338" R=1200.0000' T=214.2828' L=424.0957'

E=18.982

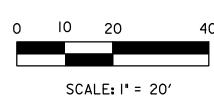

MARYLAND DEPARTMENT OF TRANSPORTATION

STATE HIGHWAY ADMINISTRATION


DISTRICT 2 PROJECT DEVELOPMENT MD 213 (LIBERTY STREET AND COMMERCE STREET) FROM MILL STREAM BRANCH TO GRAVEL RUN

SAFETY AND RESURFACING

McCORMICK TAYLOR

509 South Exeter Street 4th Floor Baltimore, Maryland 21202 (410) 662-7400

**ROADWAY PLAN SHEET** R / W PLAT NUMBER ROADWAY LEGEND CROSS REFERENCE REVISIONS ITEM SHEET NOs. SCALE <u>1" = 20'</u> ADVERTISED DATE <u>DEC 2019</u> CONTRACT NO. <u>QA2985177</u> CONCRETE SIDEWALK INDEX OF SHEETS .. GENERAL NOTES SHEET. TYPICAL SECTIONS . DESIGNED BY \_ COUNTY \_ QUEEN ANNE'S SIDEWALK RAMP DETAIL SHEET. LOGMILE GEOMETRIC LAYOUT SHEET.. DRAWN BY 7.06 - 7.85 RAMP CONSTRUCTION DETAIL. FINE MILLING AND RESURFACING DETECTABLE WARNING SURFACE CHECKED BY \_ GGW HORIZONTAL SCALE \_ SITE LAYOUT SHEET .. ROADWAY PLANS ... MDE/PRD \_ EXEMPT VERTICAL SCALE RIGHT-OF-WAY LINE EROSION AND SEDIMENT CONTROL NOTES. MAINTENANCE OF TRAFFIC NOTES .. EXISTING TRAFFIC FLOW ARROW DRAWING NO. PS-10 OF PS-19 SHEET NO. 19 OF 30

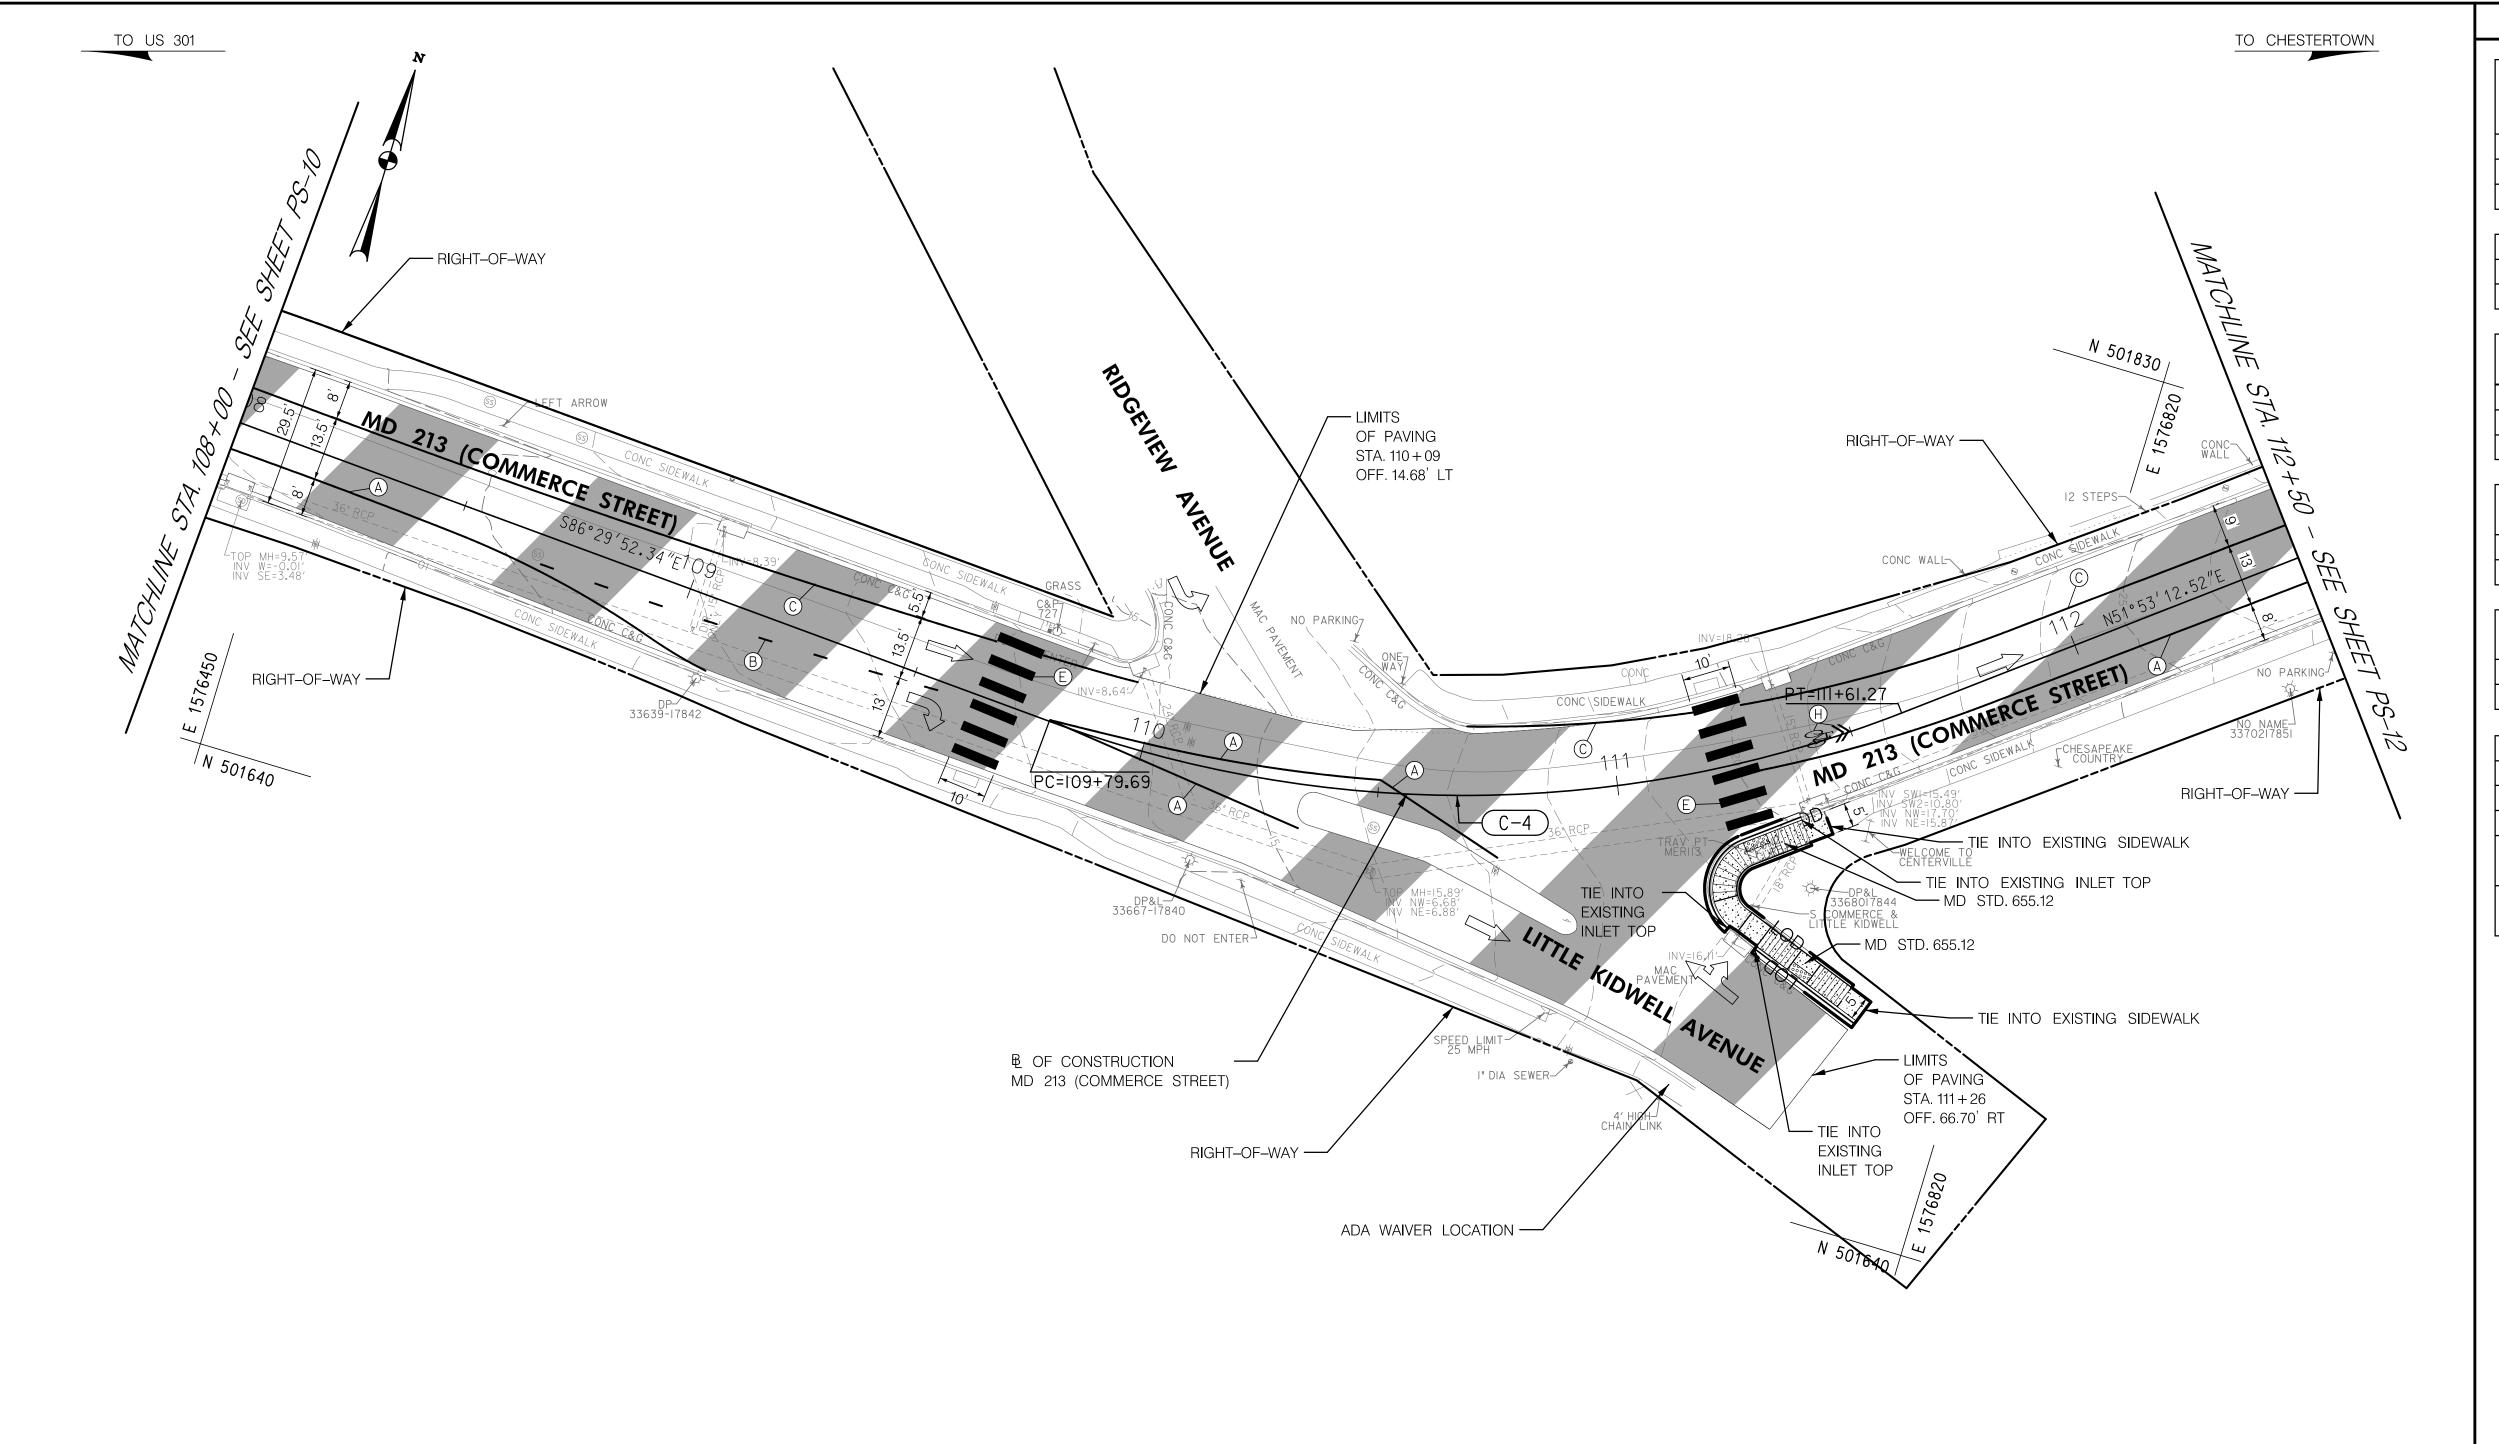

#### STANDARD TYPE A COMBINATION CURB AND GUTTER 12 INCH GUTTER PAN **8 INCH MINIMUM DEPTH** LF REMARKS STATION STA. 111+16, 33' RT TO STA. 111+35, 14' RT 36 STA. 111+20, 38' RT TO STA. 111+35, 58' RT

5 INCH CONCRETE SIDEWALK		
STATION	SF	REMARKS
STA. 111+15, RT TO STA. 111+40, RT	333	

DETECTABLE WARNING SURFACE FOR CURB RAMPS		
STATION	SF	REMARKS
STA. 111+26, 17' RT	10	
STA. 111+28, 45' RT	10	

FINE MILLING ASPHALT PA		NT		
STATION SY REMAR				
STA 108+00 TO STA. 112+50	1,709			

STANDARD TYPE A CURB 8 INCH X 16 INCH MINIMUM		
STATION	LF	REMARKS
STA 111+36, 20' RT TO STA. 111+36, 51' RT	50	

PAVEMENT MARKINGS				
DESCRIPTION	QUANTITY	UNIT		
5 INCH WHITE THERMO. PAVEMENT MARKINGS	413	LF		
5 INCH YELLOW THERMO. PAVEMENT MARKINGS	355	LF		
24 INCH WHITE PREFORMED THERMOPLASTIC	120	ור		
PAVEMENT MARKING LINE	120	LF		
SHARED BIKE LANE PREFORMED THERMOPLASTIC	9	SF		
PAVEMENT MARKING WITH ARROW	9	3F		

CONCRETE SIDEWALK

DETECTABLE WARNING SURFACE

SIDEWALK RAMP

RIGHT-OF-WAY LINE

- LOD - LIMIT OF DISTURBANCE

(A) 5 INCH WHITE THERMOPLASTIC PAVEMENT MARKINGS (SOLID) (B) 5 INCH WHITE THERMOPLASTIC PAVEMENT MARKINGS (3 FOOT LINE /9 FOOT GAP)

(C) 5 INCH YELLOW THERMOPLASTIC PAVEMENT MARKINGS (SOLID)

(D) 12 INCH WHITE PREFORMED THERMOPLASTIC PAVEMENT MARKING LINE (SOLID) (E) 24 INCH WHITE PREFORMED THERMOPLASTIC PAVEMENT MARKING LINE (SOLID)

PAVEMENT MARKING LEGEND

F) WHITE PREFORMED THERMOPLASTIC PAVEMENT MARKING LEGENDS AND SYMBOLS G BIKE LANE PREFORMED THERMOPLASTIC PAVEMENT MARKING WITH ARROW

(H) SHARED BIKE LANE PREFORMED THERMOPLASTIC PAVEMENT MARKING WITH ARROW

SEDIMENT AND EROSION CONTROL REGULATIONS WILL BE STRICTLY ENFORCED DURING CONSTRUCTION.

ALL DISTURBED AREAS SHALL BE STABILIZED AT THE END OF EACH WORK DAY WITH TEMPORARY STRAW MULCH PER SP 704 IN PERVIOUS AREAS OR GRADED AGGREGATE BASE COURSE IN IMPERVIOUS AREAS. CONTRACTOR SHALL INVENTORY ALL PAVEMENT MARKINGS BEFORE FINE MILLING.

 $\triangle = 41^{\circ} 36'55.1425"$ Dc=22°55′05.9225" R=250.0000′ T=95.0043' L=181**.**5811′ E=17**.**4431 R / W PLAT NUMBER ROADWAY LEGEND CROSS REFERENCE

FINE MILLING AND RESURFACING

EXISTING TRAFFIC FLOW ARROW

ITEM

INDEX OF SHEETS .. GENERAL NOTES SHEET.

TYPICAL SECTIONS .

SITE LAYOUT SHEET .. ROADWAY PLANS ...

GEOMETRIC LAYOUT SHEET..

RAMP CONSTRUCTION DETAIL.

MAINTENANCE OF TRAFFIC NOTES ..

EROSION AND SEDIMENT CONTROL NOTES.

DETAIL SHEET.

0 10 20 SCALE: I" = 20'

REVISIONS

SHEET NOs.



STATE HIGHWAY

ADMINISTRATION

PROJECT DEVELOPMENT MD 213 (LIBERTY STREET AND COMMERCE STREET) FROM MILL STREAM BRANCH TO GRAVEL RUN SAFETY AND RESURFACING

DISTRICT 2


SCALE 1" = 20' ADVERTISED DATE DEC 2019 CONTRACT NO. QA2985177 DESIGNED BY \_ COUNTY \_ QUEEN ANNE'S LOGMILE DRAWN BY 7.06 - 7.85 CHECKED BY \_ GGW HORIZONTAL SCALE \_ MDE/PRD \_ EXEMPT VERTICAL SCALE SHEET NO. 20 OF 30 DRAWING NO. PS-11 OF PS-19


**ROADWAY PLAN SHEET** 

McCORMICK TAYLOR 509 South Exeter Street

4th Floor Baltimore, Maryland 21202 (410) 662-7400

PLOTTED: Monday, December 09, 2019 AT 01:44 PM
FILE: \\baserver1\Projects\5871\_MD\_MDSHA\_SurveyEng\07\_On-site Support for Fund 77\300\_CADD\Plan\_Set\Roadway\MD 213\pHD-P011\_MD 213.dgn

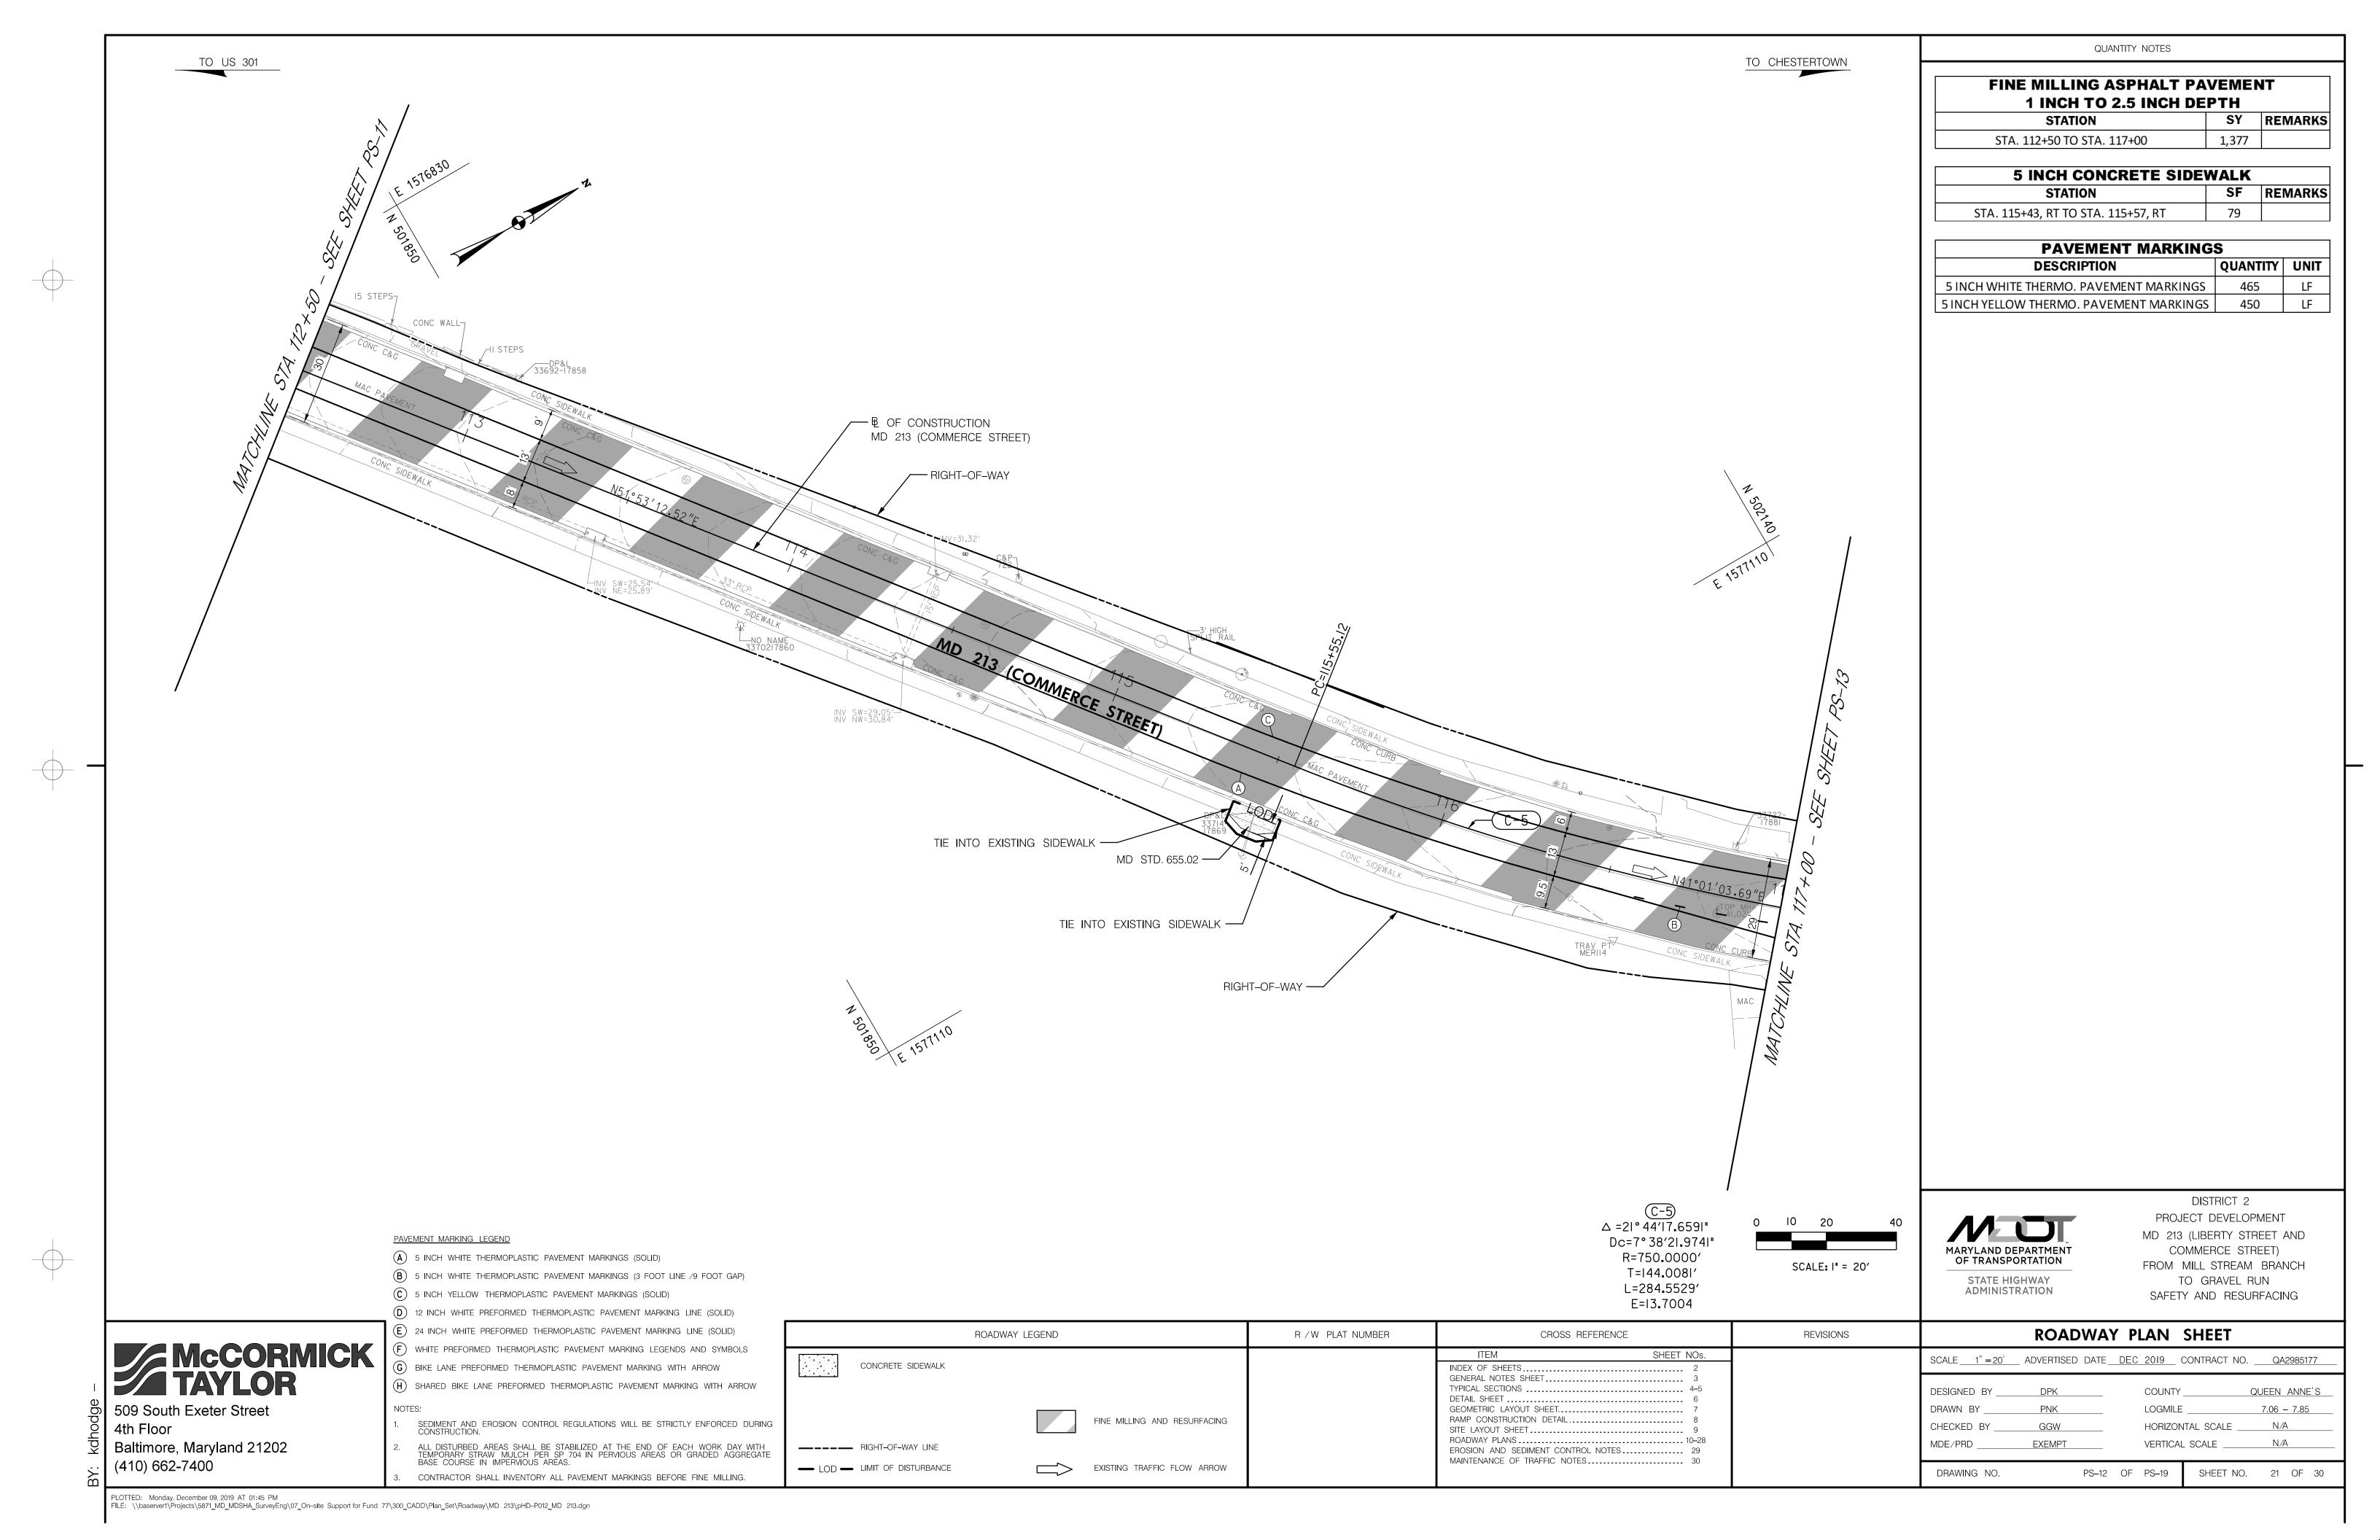

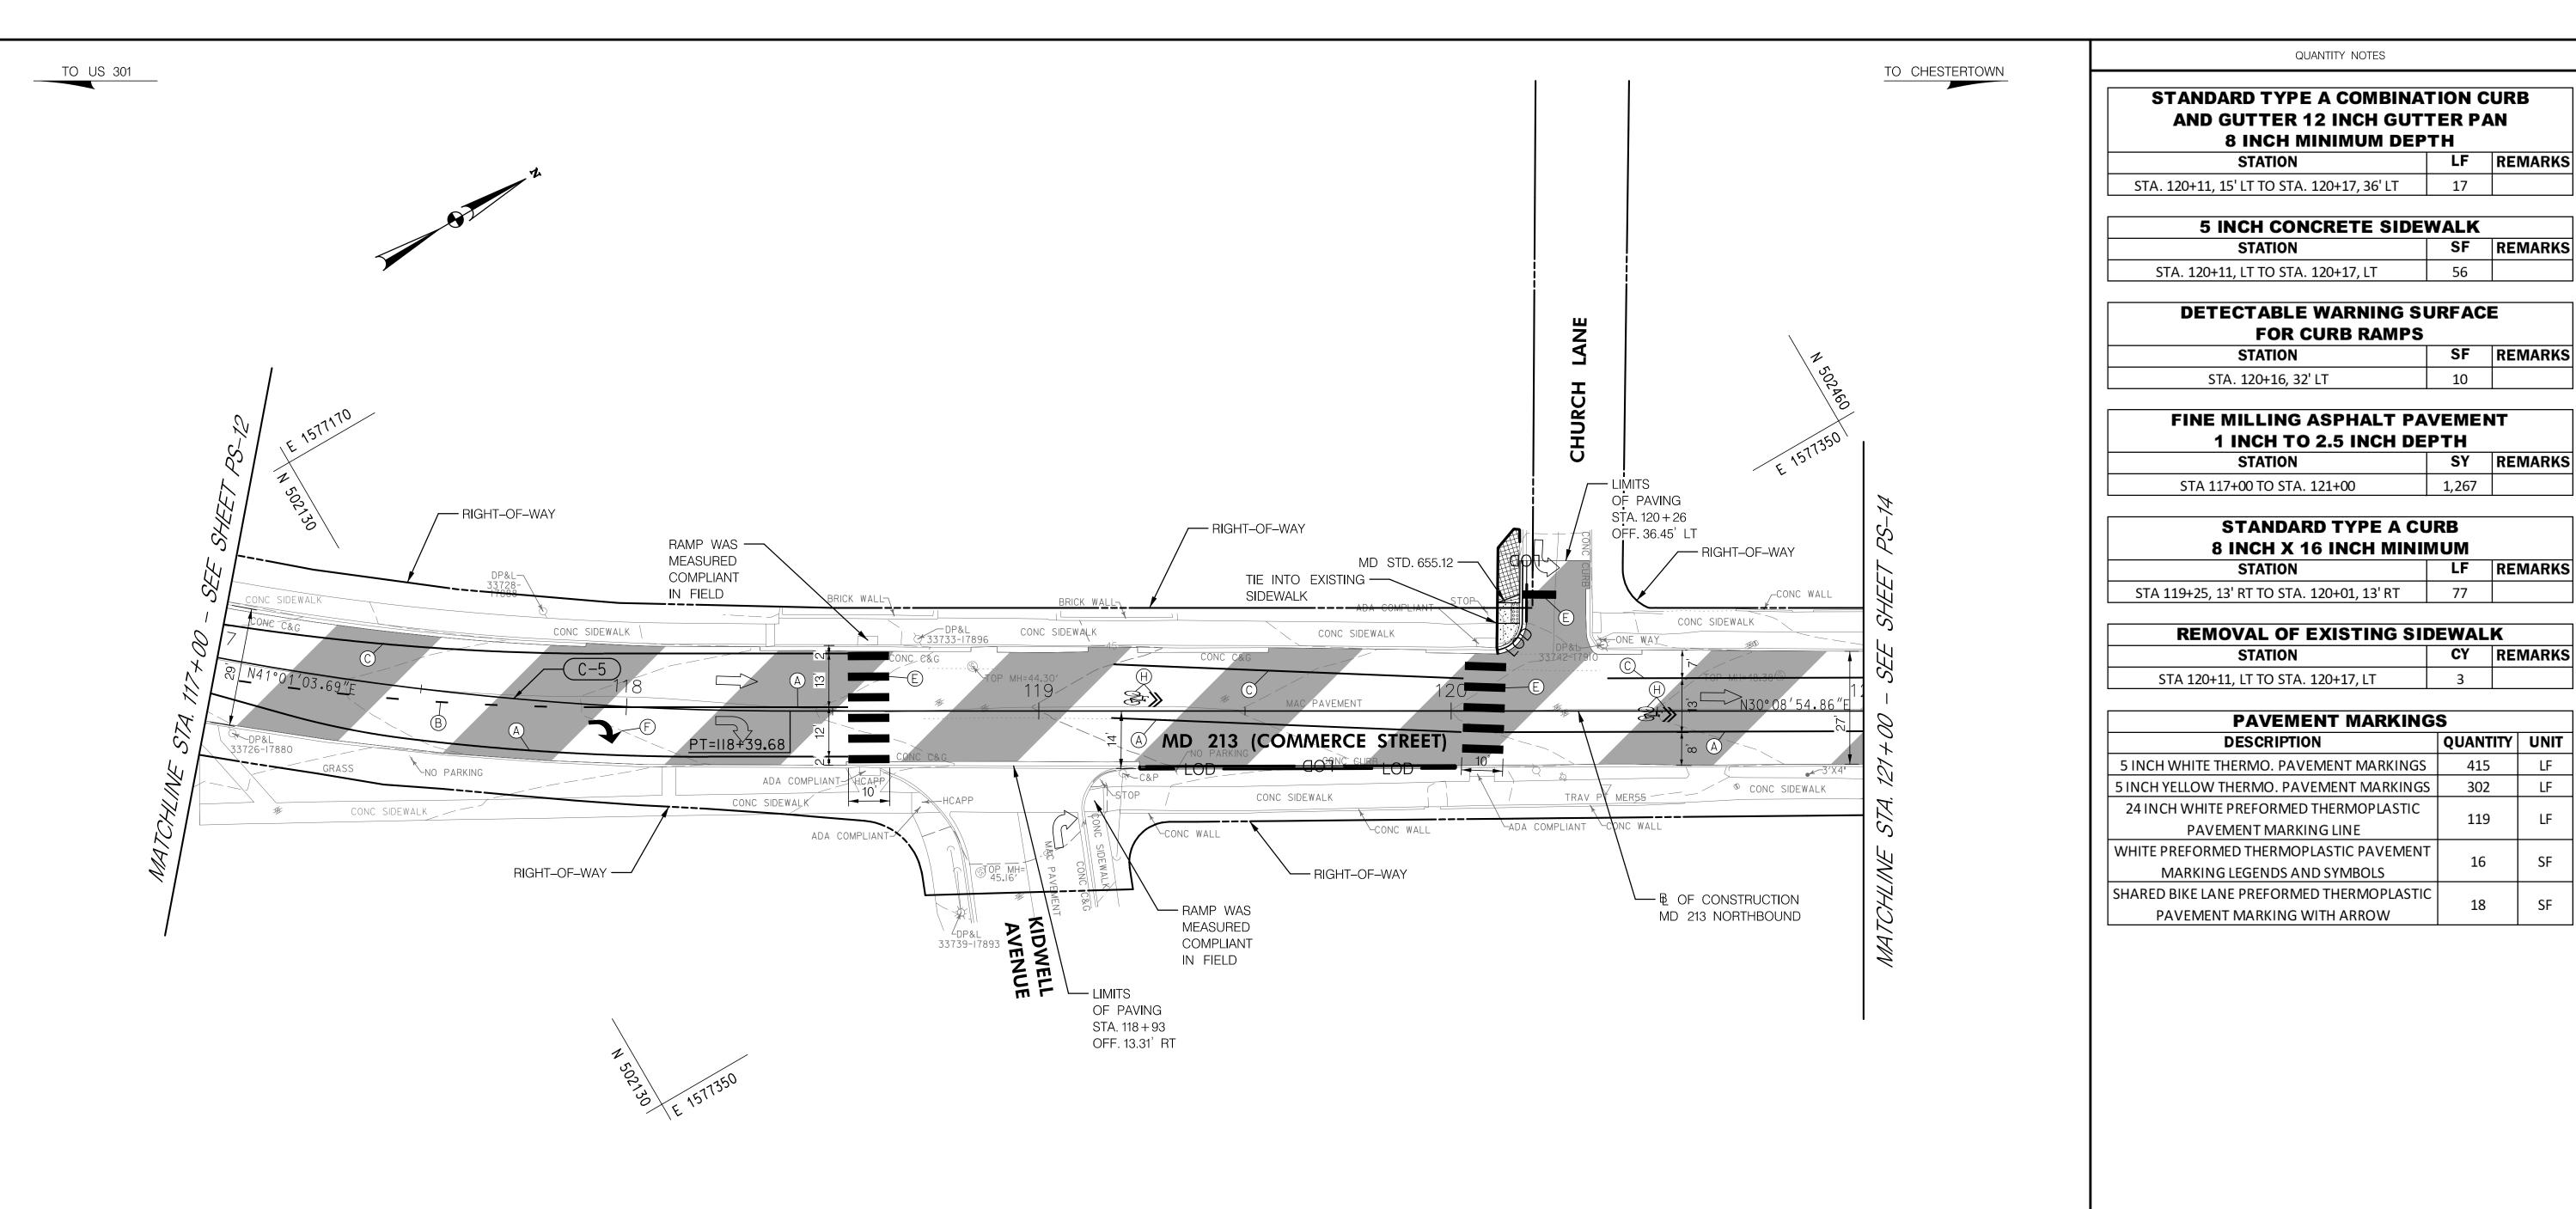

PAVEMENT MARKING LEGEND

(A) 5 INCH WHITE THERMOPLASTIC PAVEMENT MARKINGS (SOLID)

(B) 5 INCH WHITE THERMOPLASTIC PAVEMENT MARKINGS (3 FOOT LINE /9 FOOT GAP) © 5 INCH YELLOW THERMOPLASTIC PAVEMENT MARKINGS (SOLID)

(D) 12 INCH WHITE PREFORMED THERMOPLASTIC PAVEMENT MARKING LINE (SOLID)

(E) 24 INCH WHITE PREFORMED THERMOPLASTIC PAVEMENT MARKING LINE (SOLID)

ALL DISTURBED AREAS SHALL BE STABILIZED AT THE END OF EACH WORK DAY WITH TEMPORARY STRAW MULCH PER SP 704 IN PERVIOUS AREAS OR GRADED AGGREGATE BASE COURSE IN IMPERVIOUS AREAS.

CONTRACTOR SHALL INVENTORY ALL PAVEMENT MARKINGS BEFORE FINE MILLING.

 $\triangle = 21^{\circ} 44'17.6591"$ Dc=7°38′21.9741" R=750.0000′ T=144.0081' L=284.5529'

E=13.7004






STATE HIGHWAY ADMINISTRATION

DISTRICT 2 PROJECT DEVELOPMENT MD 213 (LIBERTY STREET AND COMMERCE STREET) FROM MILL STREAM BRANCH TO GRAVEL RUN

SAFETY AND RESURFACING


SF

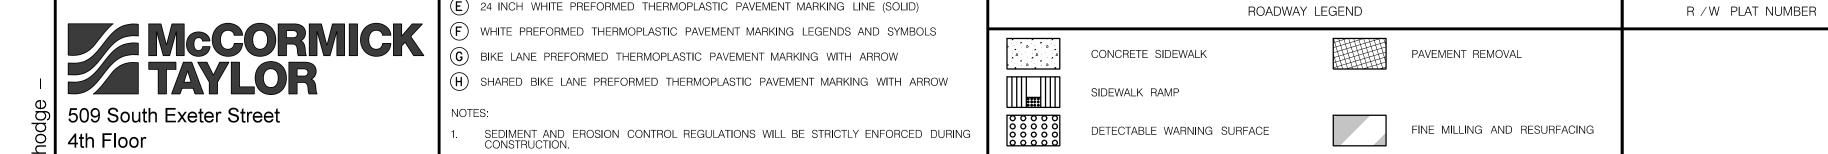

ROADWAY LEGEND	R /W PLAT NUMBER	CROSS REFERENCE	REVISIONS	ROADWAY PLAN SHEET
CONCRETE SIDEWALK PAVEMENT REMOVAL		ITEM SHEET NOs. INDEX OF SHEETS		SCALE 1" = 20' ADVERTISED DATE DEC 2019 CONTRACT NO. QA2985177
SIDEWALK RAMP		GENERAL NOTES SHEET 3 TYPICAL SECTIONS 4-5 DETAIL SHEET 6		DESIGNED BY DPK COUNTY QUEEN ANNE'S
DOOD DETECTABLE WARNING SURFACE FINE MILLING AND RESURFACING		GEOMETRIC LAYOUT SHEET		DRAWN BY PNK         LOGMILE 7.06 - 7.85           CHECKED BY GGW         HORIZONTAL SCALE N/A
RIGHT-OF-WAY LINE		ROADWAY PLANS		MDE/PRD <u>EXEMPT</u> VERTICAL SCALE <u>N/A</u>
LOD — LIMIT OF DISTURBANCE EXISTING TRAFFIC FLOW ARROW		MAINTENANCE OF THAITTIC NOTES		DRAWING NO. PS-13 OF PS-19 SHEET NO. 22 OF 30

Baltimore, Maryland 21202 (410) 662-7400

PLOTTED: Monday, December 09, 2019 AT 01:45 PM
FILE: \\baserver1\Projects\5871\_MD\_MDSHA\_SurveyEng\07\_On-site Support for Fund 77\300\_CADD\Plan\_Set\Roadway\MD 213\pHD-P013\_MD 213.dgn

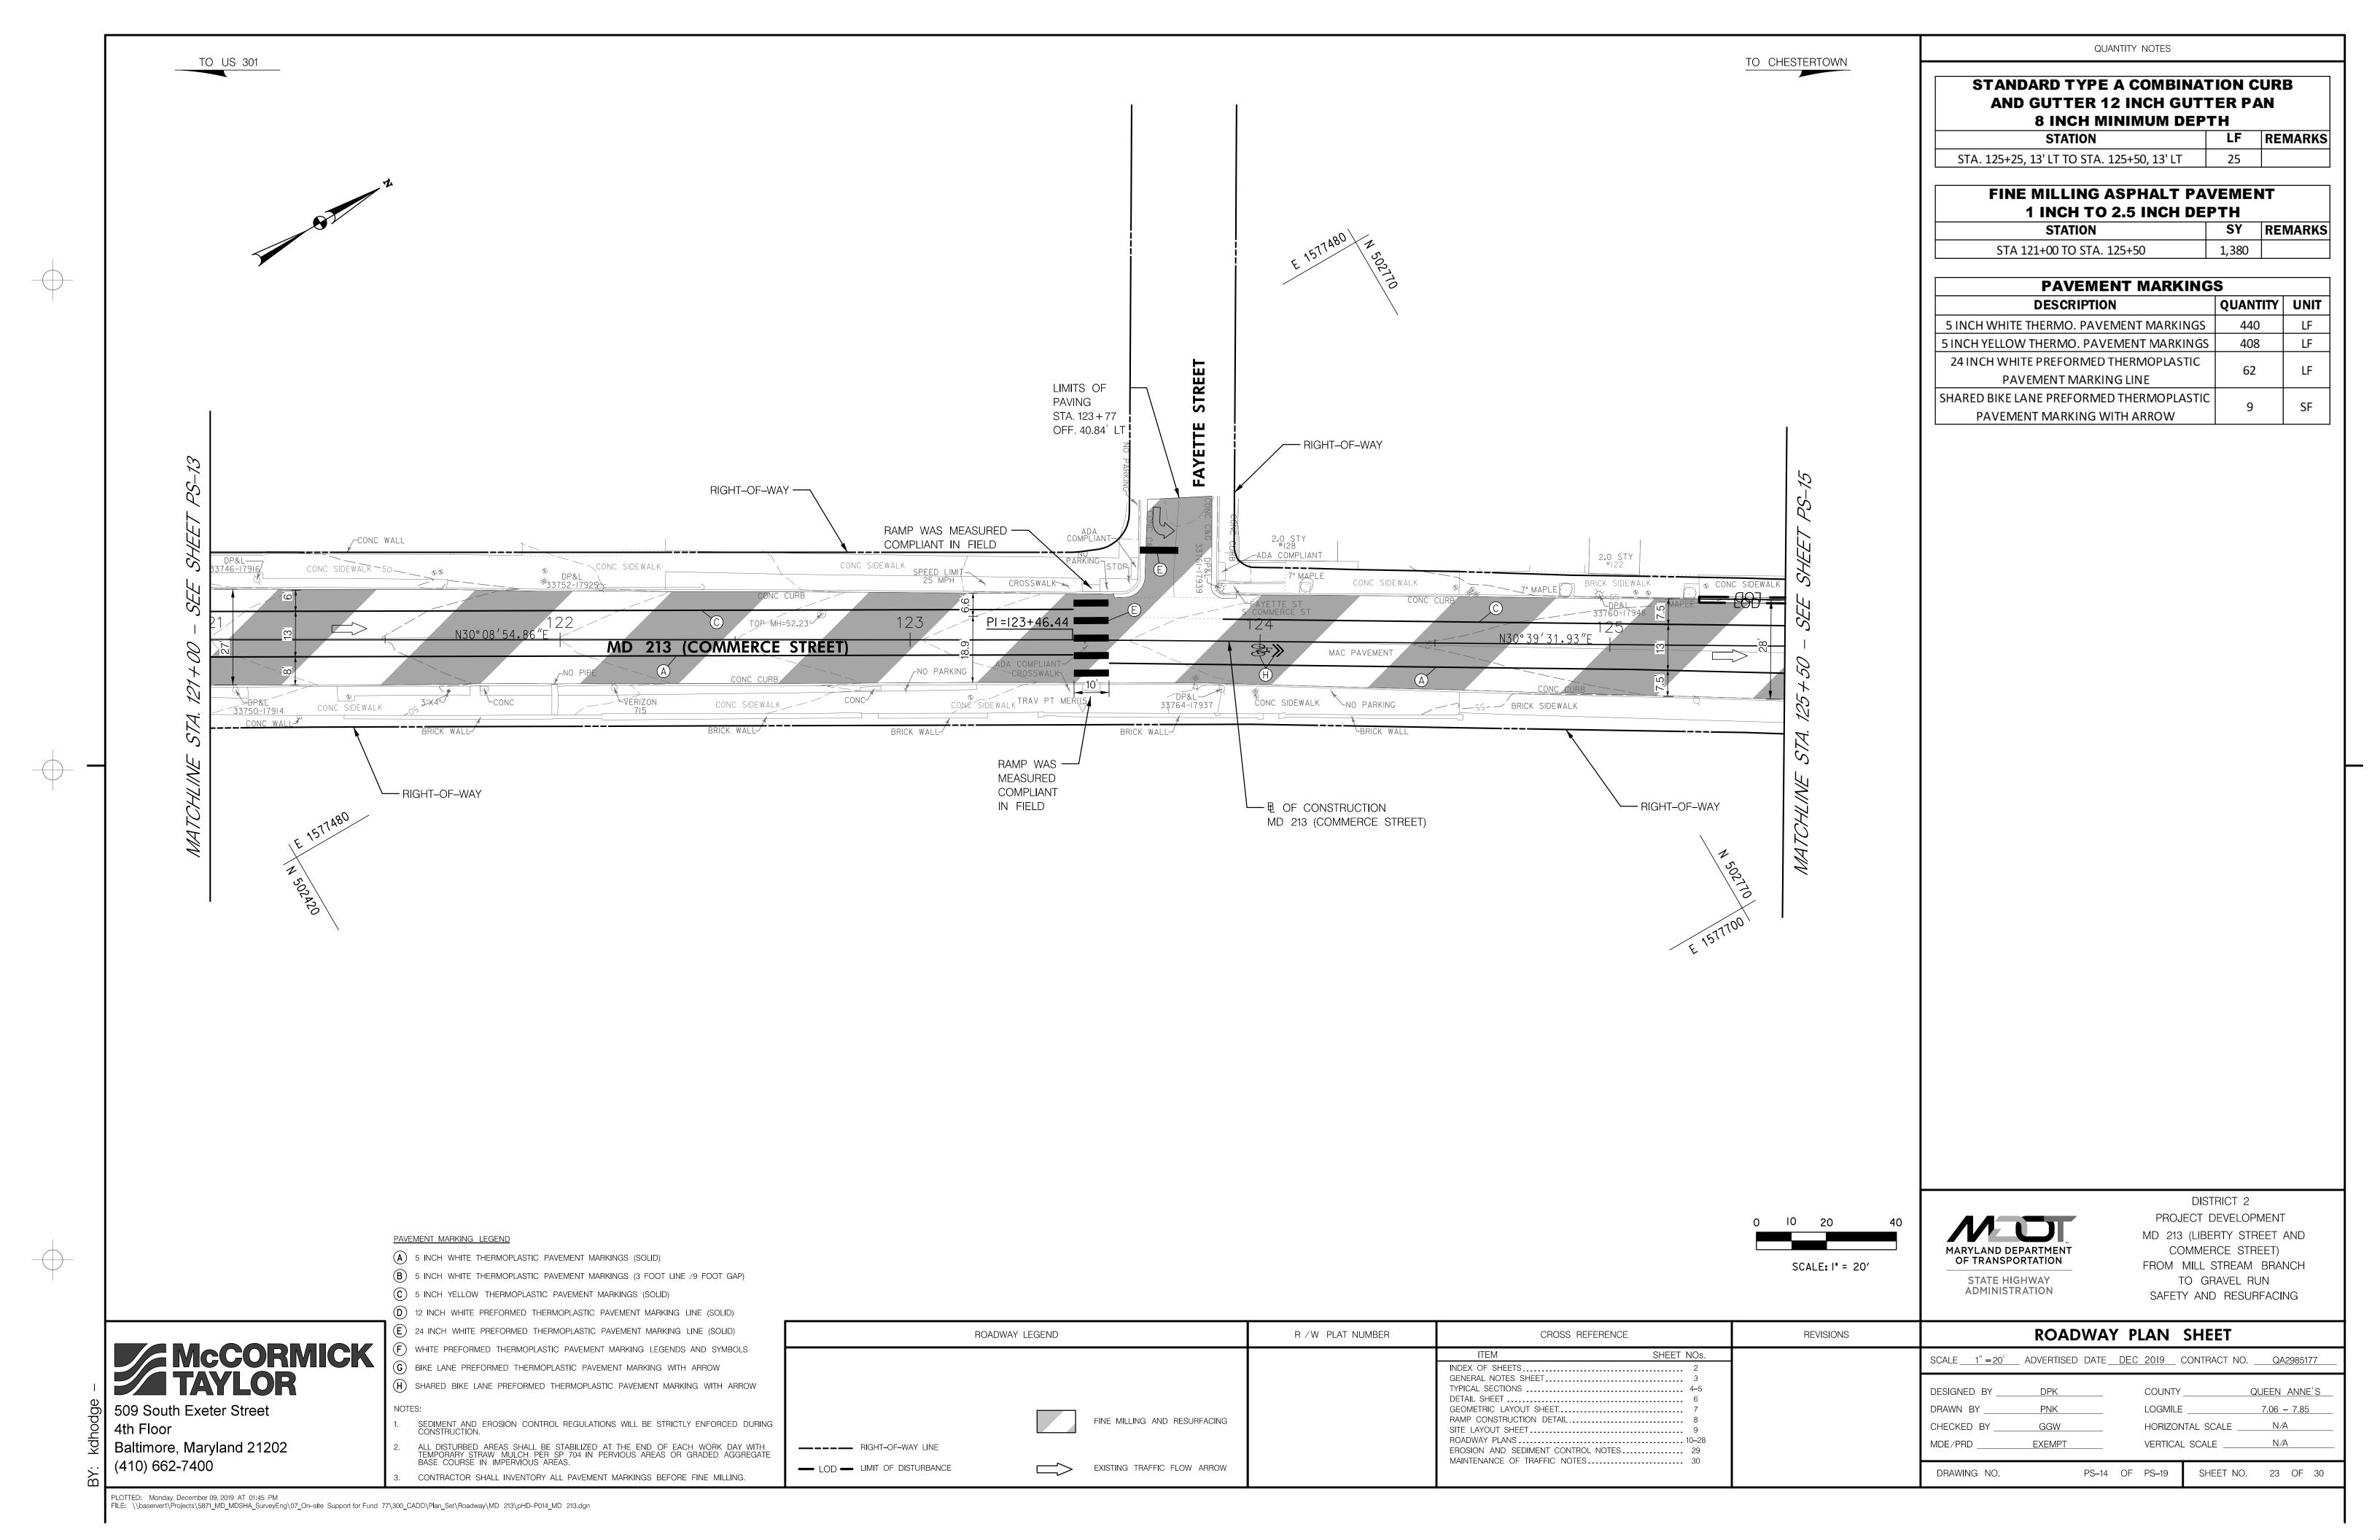

FINE MILLING ASPHALT PAVEMENT 1 INCH TO 2.5 INCH DEPTH SY REMARKS STATION STA. 227+50 TO STA. 232+00 1,840

QUANTITY NOTES

STANDARD TYPE A COMBINATION CURB AND GUTTER 12 INCH GUTTER PAN 8 INCH MINIMUM DEPTH LF REMARKS STATION

STA. 229+85, 31' RT TO STA. 229+95, 39' RT

**BRICK SIDEWALK** SF REMARKS STATION 25 STA. 229+87, RT TO STA. 229+92, RT

15

DETECTABLE WARNING SURFACE **USING BRICK PAVERS** STATION SF REMARKS 10 STA. 229+89, 33' RT STA. 229+93, 37' RT 10

5 INCH CONCRETE SIDEWALK SF REMARKS STATION STA. 229+92, RT TO STA. 229+93, RT

PAVEMENT MARKING	S	
DESCRIPTION	QUANTITY	UNIT
5 INCH WHITE THERMO. PAVEMENT MARKINGS	867	LF
5 INCH YELLOW THERMO. PAVEMENT MARKINGS	257	LF
12 INCH WHITE PREFORMED THERMOPLASTIC	333	IF
PAVEMENT MARKING LINE	333	LF
24 INCH WHITE PREFORMED THERMOPLASTIC	50	IF
PAVEMENT MARKING LINE	50	ᄕ
WHITE PREFORMED THERMOPLASTIC PAVEMENT	E 7	SF
MARKING LEGENDS AND SYMBOLS	57	SF.
SHARED BIKE LANE PREFORMED THERMOPLASTIC	10	СГ
PAVEMENT MARKING WITH ARROW	18	SF

SIGNS QUANTITY UNIT DESCRIPTION SHEET ALUMINUM GROUND MOUNTED SIGN SQUARE PERFORATED TUBULAR STEEL SIGN POSTS


RAMP WAS -- ADA WAIVER LOCATION MEASURED COMPLIANT - REPLACE EXISTING CURB IN FIELD ADA COMPLIANT-2.0 STY #114 RIGHT-OF-WAY -2.0 STY #II6 CONC SIDEWALK MD 213 (COMMERCE STREET) B OF CONSTRUCTION MD 213 (COMMERCE STREET) — TIE INTO EXISTING SIDEWALK CONC C&G BRICK SIDEWALK CONC SIDEWALK PICKET FENCE ACCESS TO BASEMEN 2.0 STY RAMP WAS MEASURED — 3.0 STY #102 NO INVERT—/ DRAINS TO CURB COMPLIANT IN FIELD MD STD. 655.12 RIGHT-OF-WAY ADA WAIVER LOCATION ADA WAIVER LOCATION -TIE INTO EXISTING SIDEWALK — R4-11 (30"×30") 6.25 S.F. RIGHT-OF-WAY RIGHT-OF-WAY ---

PAVEMENT MARKING LEGEND

(E) 24 INCH WHITE PREFORMED THERMOPLASTIC PAVEMENT MARKING LINE (SOLID)

ALL DISTURBED AREAS SHALL BE STABILIZED AT THE END OF EACH WORK DAY WITH TEMPORARY STRAW MULCH PER SP 704 IN PERVIOUS AREAS OR GRADED AGGREGATE BASE COURSE IN IMPERVIOUS AREAS.

CONTRACTOR SHALL INVENTORY ALL PAVEMENT MARKINGS BEFORE FINE MILLING.

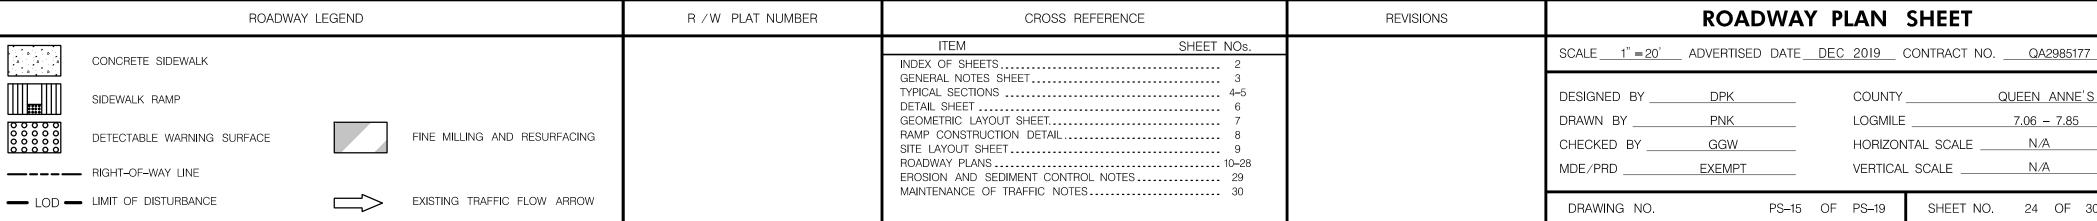

509 South Exeter Street 4th Floor Baltimore, Maryland 21202

(410) 662-7400

PLOTTED: Monday, December 09, 2019 AT 01:45 PM
FILE: \\baserver1\Projects\5871\_MD\_MDSHA\_SurveyEng\07\_On-site Support for Fund 77\300\_CADD\Plan\_Set\Roadway\MD 213\pHD-P015\_MD 213.dgn

McCORMICK TAYLOR

(A) 5 INCH WHITE THERMOPLASTIC PAVEMENT MARKINGS (SOLID)

(B) 5 INCH WHITE THERMOPLASTIC PAVEMENT MARKINGS (3 FOOT LINE /9 FOOT GAP) (C) 5 INCH YELLOW THERMOPLASTIC PAVEMENT MARKINGS (SOLID)

(D) 12 INCH WHITE PREFORMED THERMOPLASTIC PAVEMENT MARKING LINE (SOLID)

F WHITE PREFORMED THERMOPLASTIC PAVEMENT MARKING LEGENDS AND SYMBOLS G BIKE LANE PREFORMED THERMOPLASTIC PAVEMENT MARKING WITH ARROW (H) SHARED BIKE LANE PREFORMED THERMOPLASTIC PAVEMENT MARKING WITH ARROW

SEDIMENT AND EROSION CONTROL REGULATIONS WILL BE STRICTLY ENFORCED DURING CONSTRUCTION.

SCALE: I" = 20'

MARYLAND DEPARTMENT OF TRANSPORTATION STATE HIGHWAY

**ADMINISTRATION** 

GGW

DISTRICT 2 PROJECT DEVELOPMENT MD 213 (LIBERTY STREET AND COMMERCE STREET) FROM MILL STREAM BRANCH TO GRAVEL RUN

QUEEN ANNE'S

7.06 - 7.85

SHEET NO. 24 OF 30

SAFETY AND RESURFACING **ROADWAY PLAN SHEET** 


COUNTY \_

LOGMILE

PS-15 OF PS-19

HORIZONTAL SCALE \_

VERTICAL SCALE

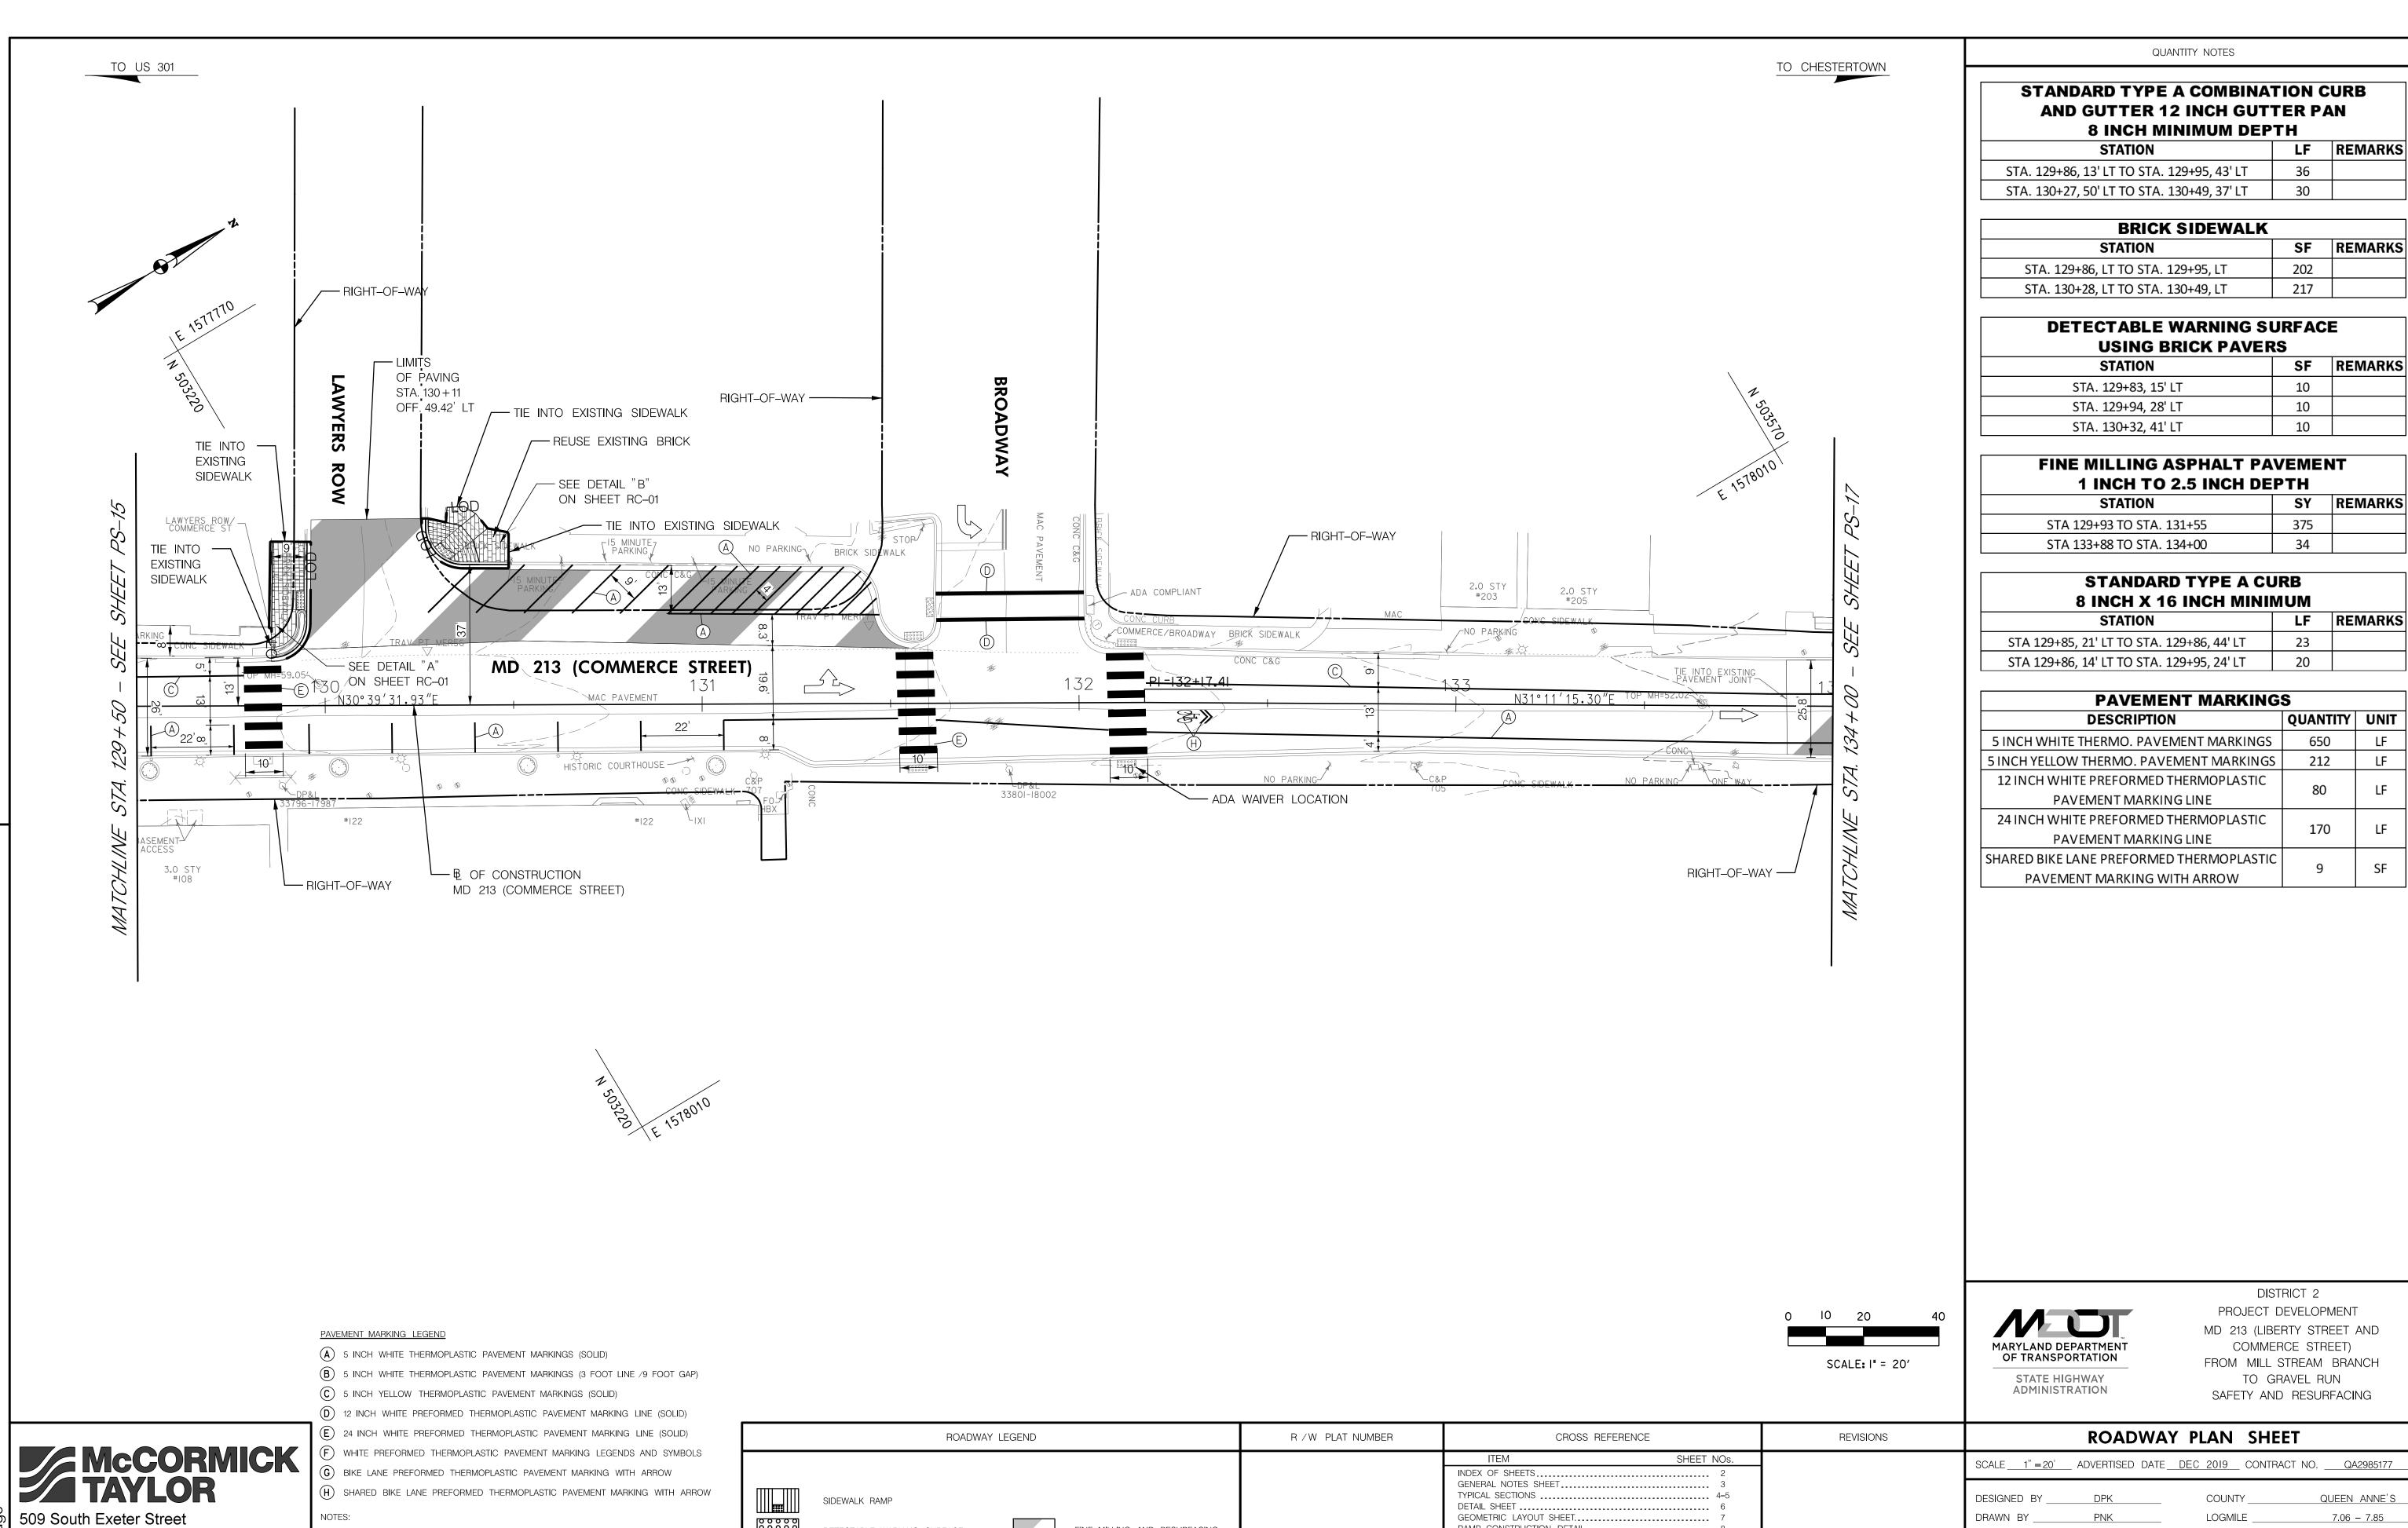

FINE MILLING AND RESURFACING

EXISTING TRAFFIC FLOW ARROW

BRICK SIDEWALK

DETECTABLE WARNING SURFACE

RIGHT-OF-WAY LINE

- LOD - LIMIT OF DISTURBANCE

RAMP CONSTRUCTION DETAIL.

EROSION AND SEDIMENT CONTROL NOTES. MAINTENANCE OF TRAFFIC NOTES...

SITE LAYOUT SHEET .. ROADWAY PLANS ..

650

212

170

QUEEN ANNE'S

7.06 - 7.85

SHEET NO. 25 OF 30

HORIZONTAL SCALE \_

VERTICAL SCALE

PS-16 OF PS-19

CHECKED BY

DRAWING NO.

MDE/PRD \_

GGW

EXEMPT

4th Floor Baltimore, Maryland 21202


(410) 662-7400

PLOTTED: Monday, December 09, 2019 AT 01:45 PM FILE: \\baserver1\Projects\5871\_MD\_MDSHA\_SurveyEng\07\_On-site Support for Fund 77\300\_CADD\Plan\_Set\Roadway\MD 213\pHD-P016\_MD 213.dgn


SEDIMENT AND EROSION CONTROL REGULATIONS WILL BE STRICTLY ENFORCED DURING CONSTRUCTION.

ALL DISTURBED AREAS SHALL BE STABILIZED AT THE END OF EACH WORK DAY WITH TEMPORARY STRAW MULCH PER SP 704 IN PERVIOUS AREAS OR GRADED AGGREGATE BASE COURSE IN IMPERVIOUS AREAS.

CONTRACTOR SHALL INVENTORY ALL PAVEMENT MARKINGS BEFORE FINE MILLING.

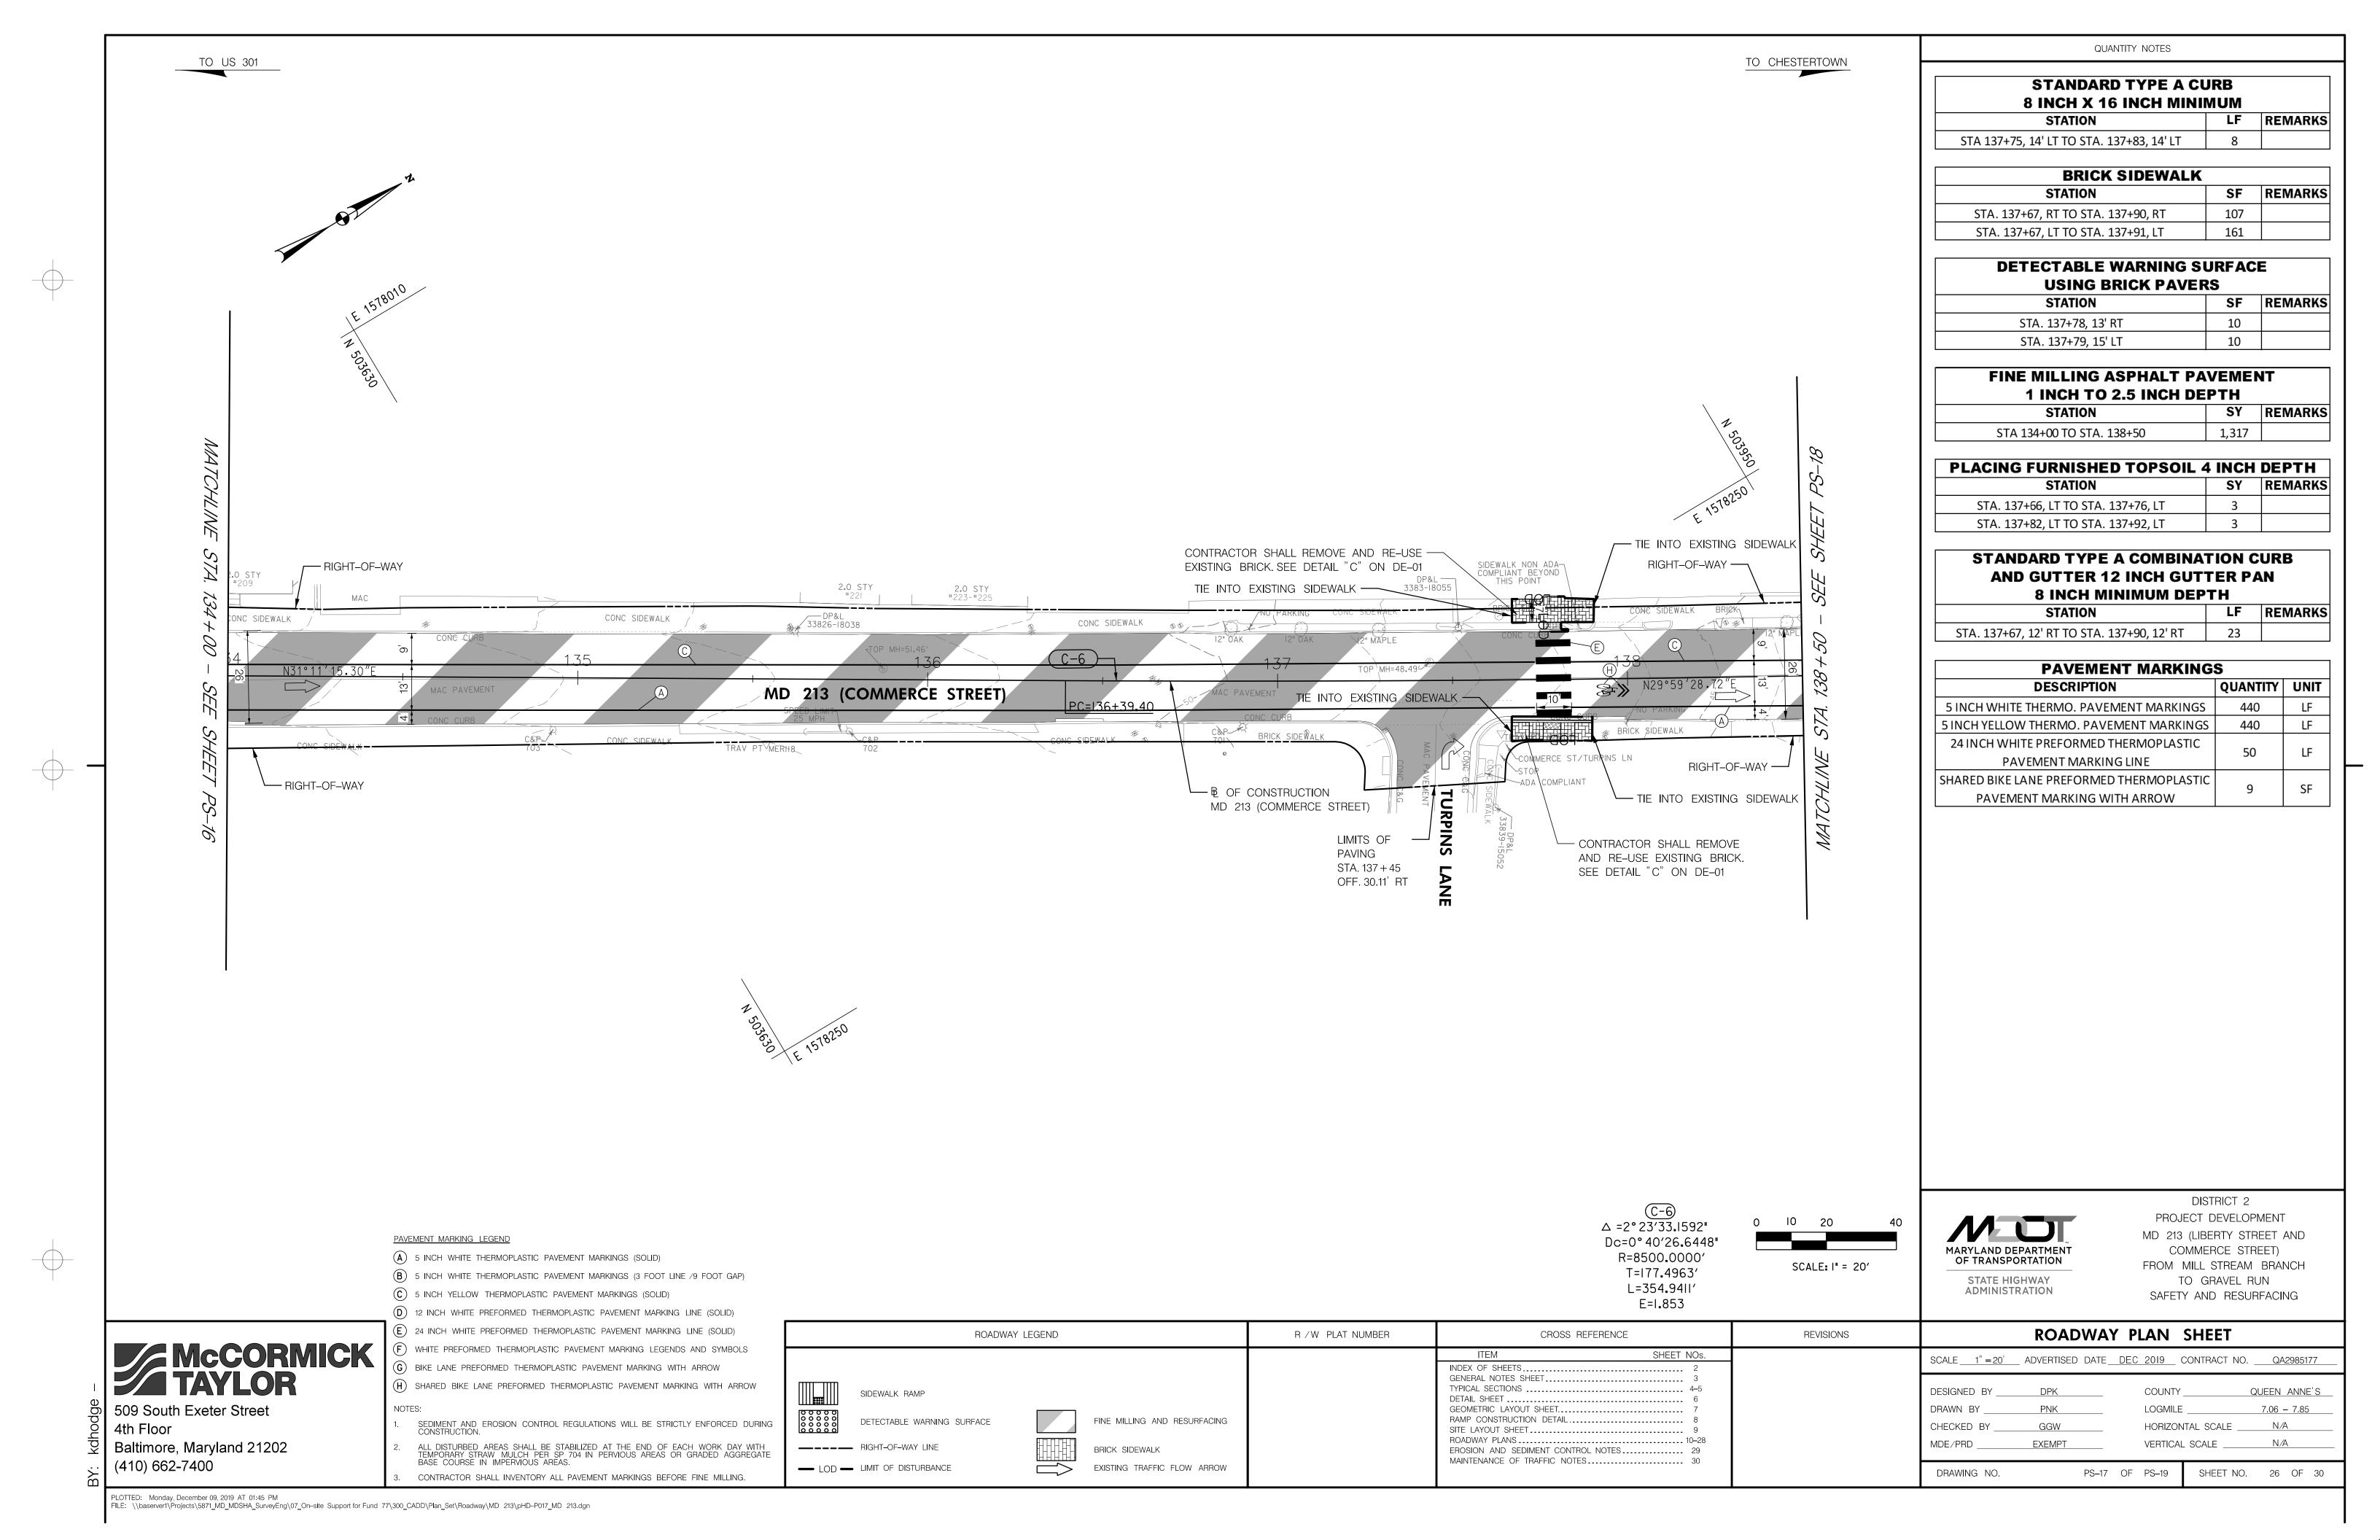



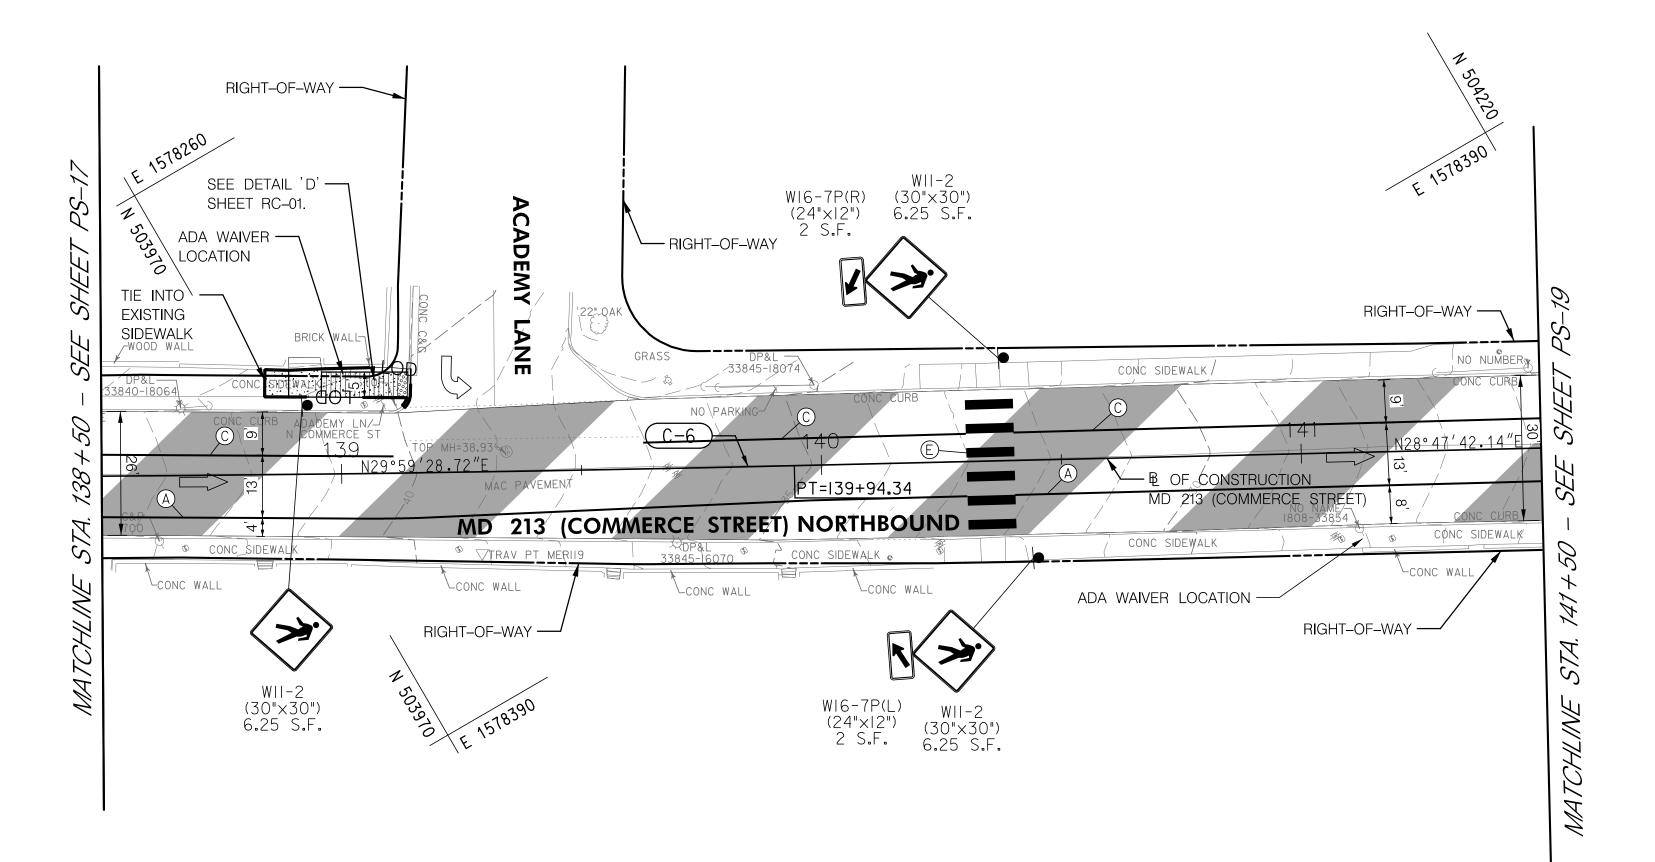

	FINE MILLING ASPHALT PA 1 INCH TO 2.5 INCH DE		NT
ı	STATION	SY	REMARKS
I	STA. 138+50 TO STA. 141+50	961	

5 INCH CONCRETE SIDEWALK			
STATION		SF	REMARKS
STA. 138+84, LT TO STA. 139+14, LT		162	

DETECTABLE WARNING SURFACE		
FOR CURB RAMPS		
STATION	SF	REMARKS
STA. 139+13, 18 LT	11	

STANDARD TYPE A CURB 8 INCH X 16 INCH MINIMUM		
STATION	LF	REMARKS
STA. 139+13, 14' LT TO STA. 139+15, 22' LT	8	
STA 138+96, 22' LT TO STA. 139+14, 22' LT	18	

PAVEMENT MARKINGS			
DESCRIPTION	QUANTITY	UNIT	
5 INCH WHITE THERMO. PAVEMENT MARKINGS	290	LF	
5 INCH YELLOW THERMO. PAVEMENT MARKINGS	239	LF	
24 INCH WHITE PREFORMED THERMOPLASTIC	60	I F	
PAVEMENT MARKING LINE	60	LF	

SIGNS							
DESCRIPTION	QUANTITY	UNIT					
SHEET ALUMINUM GROUND MOUNTED SIGN	23	SF					
SQUARE PERFORATED TUBULAR STEEL SIGN POSTS	3	EA					

PAVEMENT MARKING LEGEND

(A) 5 INCH WHITE THERMOPLASTIC PAVEMENT MARKINGS (SOLID)

(B) 5 INCH WHITE THERMOPLASTIC PAVEMENT MARKINGS (3 FOOT LINE /9 FOOT GAP)

(C) 5 INCH YELLOW THERMOPLASTIC PAVEMENT MARKINGS (SOLID)

(D) 12 INCH WHITE PREFORMED THERMOPLASTIC PAVEMENT MARKING LINE (SOLID)

(E) 24 INCH WHITE PREFORMED THERMOPLASTIC PAVEMENT MARKING LINE (SOLID) F) WHITE PREFORMED THERMOPLASTIC PAVEMENT MARKING LEGENDS AND SYMBOLS

G BIKE LANE PREFORMED THERMOPLASTIC PAVEMENT MARKING WITH ARROW H SHARED BIKE LANE PREFORMED THERMOPLASTIC PAVEMENT MARKING WITH ARROW

SEDIMENT AND EROSION CONTROL REGULATIONS WILL BE STRICTLY ENFORCED DURING CONSTRUCTION.

ALL DISTURBED AREAS SHALL BE STABILIZED AT THE END OF EACH WORK DAY WITH TEMPORARY STRAW MULCH PER SP 704 IN PERVIOUS AREAS OR GRADED AGGREGATE BASE COURSE IN IMPERVIOUS AREAS.

CONTRACTOR SHALL INVENTORY ALL PAVEMENT MARKINGS BEFORE FINE MILLING.

CONCRETE SIDEWALK SIDEWALK RAMP DETECTABLE WARNING SURFACE FINE MILLING AND RESURFACING ----- RIGHT-OF-WAY LINE

0 10 20  $\triangle = 2^{\circ} 23'33.1592"$ Dc=0°40′26.6448" SCALE: I" = 20'



STATE HIGHWAY **ADMINISTRATION** 

DISTRICT 2 PROJECT DEVELOPMENT MD 213 (LIBERTY STREET AND COMMERCE STREET) FROM MILL STREAM BRANCH TO GRAVEL RUN SAFETY AND RESURFACING

McCORMICK TAYLOR 509 South Exeter Street

4th Floor Baltimore, Maryland 21202 (410) 662-7400


**ROADWAY PLAN SHEET** R / W PLAT NUMBER ROADWAY LEGEND CROSS REFERENCE REVISIONS ITEM SHEET NOs. SCALE <u>1" = 20'</u> ADVERTISED DATE <u>DEC 2019</u> CONTRACT NO. <u>QA2985177</u> INDEX OF SHEETS .. GENERAL NOTES SHEET. TYPICAL SECTIONS . DESIGNED BY \_\_\_ COUNTY \_ QUEEN ANNE'S DETAIL SHEET. LOGMILE GEOMETRIC LAYOUT SHEET .. DRAWN BY 7.06 - 7.85 RAMP CONSTRUCTION DETAIL. HORIZONTAL SCALE \_ CHECKED BY \_ GGW SITE LAYOUT SHEET .. ROADWAY PLANS ... MDE/PRD \_\_\_ EXEMPT VERTICAL SCALE EROSION AND SEDIMENT CONTROL NOTES. MAINTENANCE OF TRAFFIC NOTES ... EXISTING TRAFFIC FLOW ARROW SHEET NO. 27 OF 30 DRAWING NO. PS-18 OF PS-19

R=8500.0000′

T=177.4963'

L=354**.**9411′

E=I**.**853

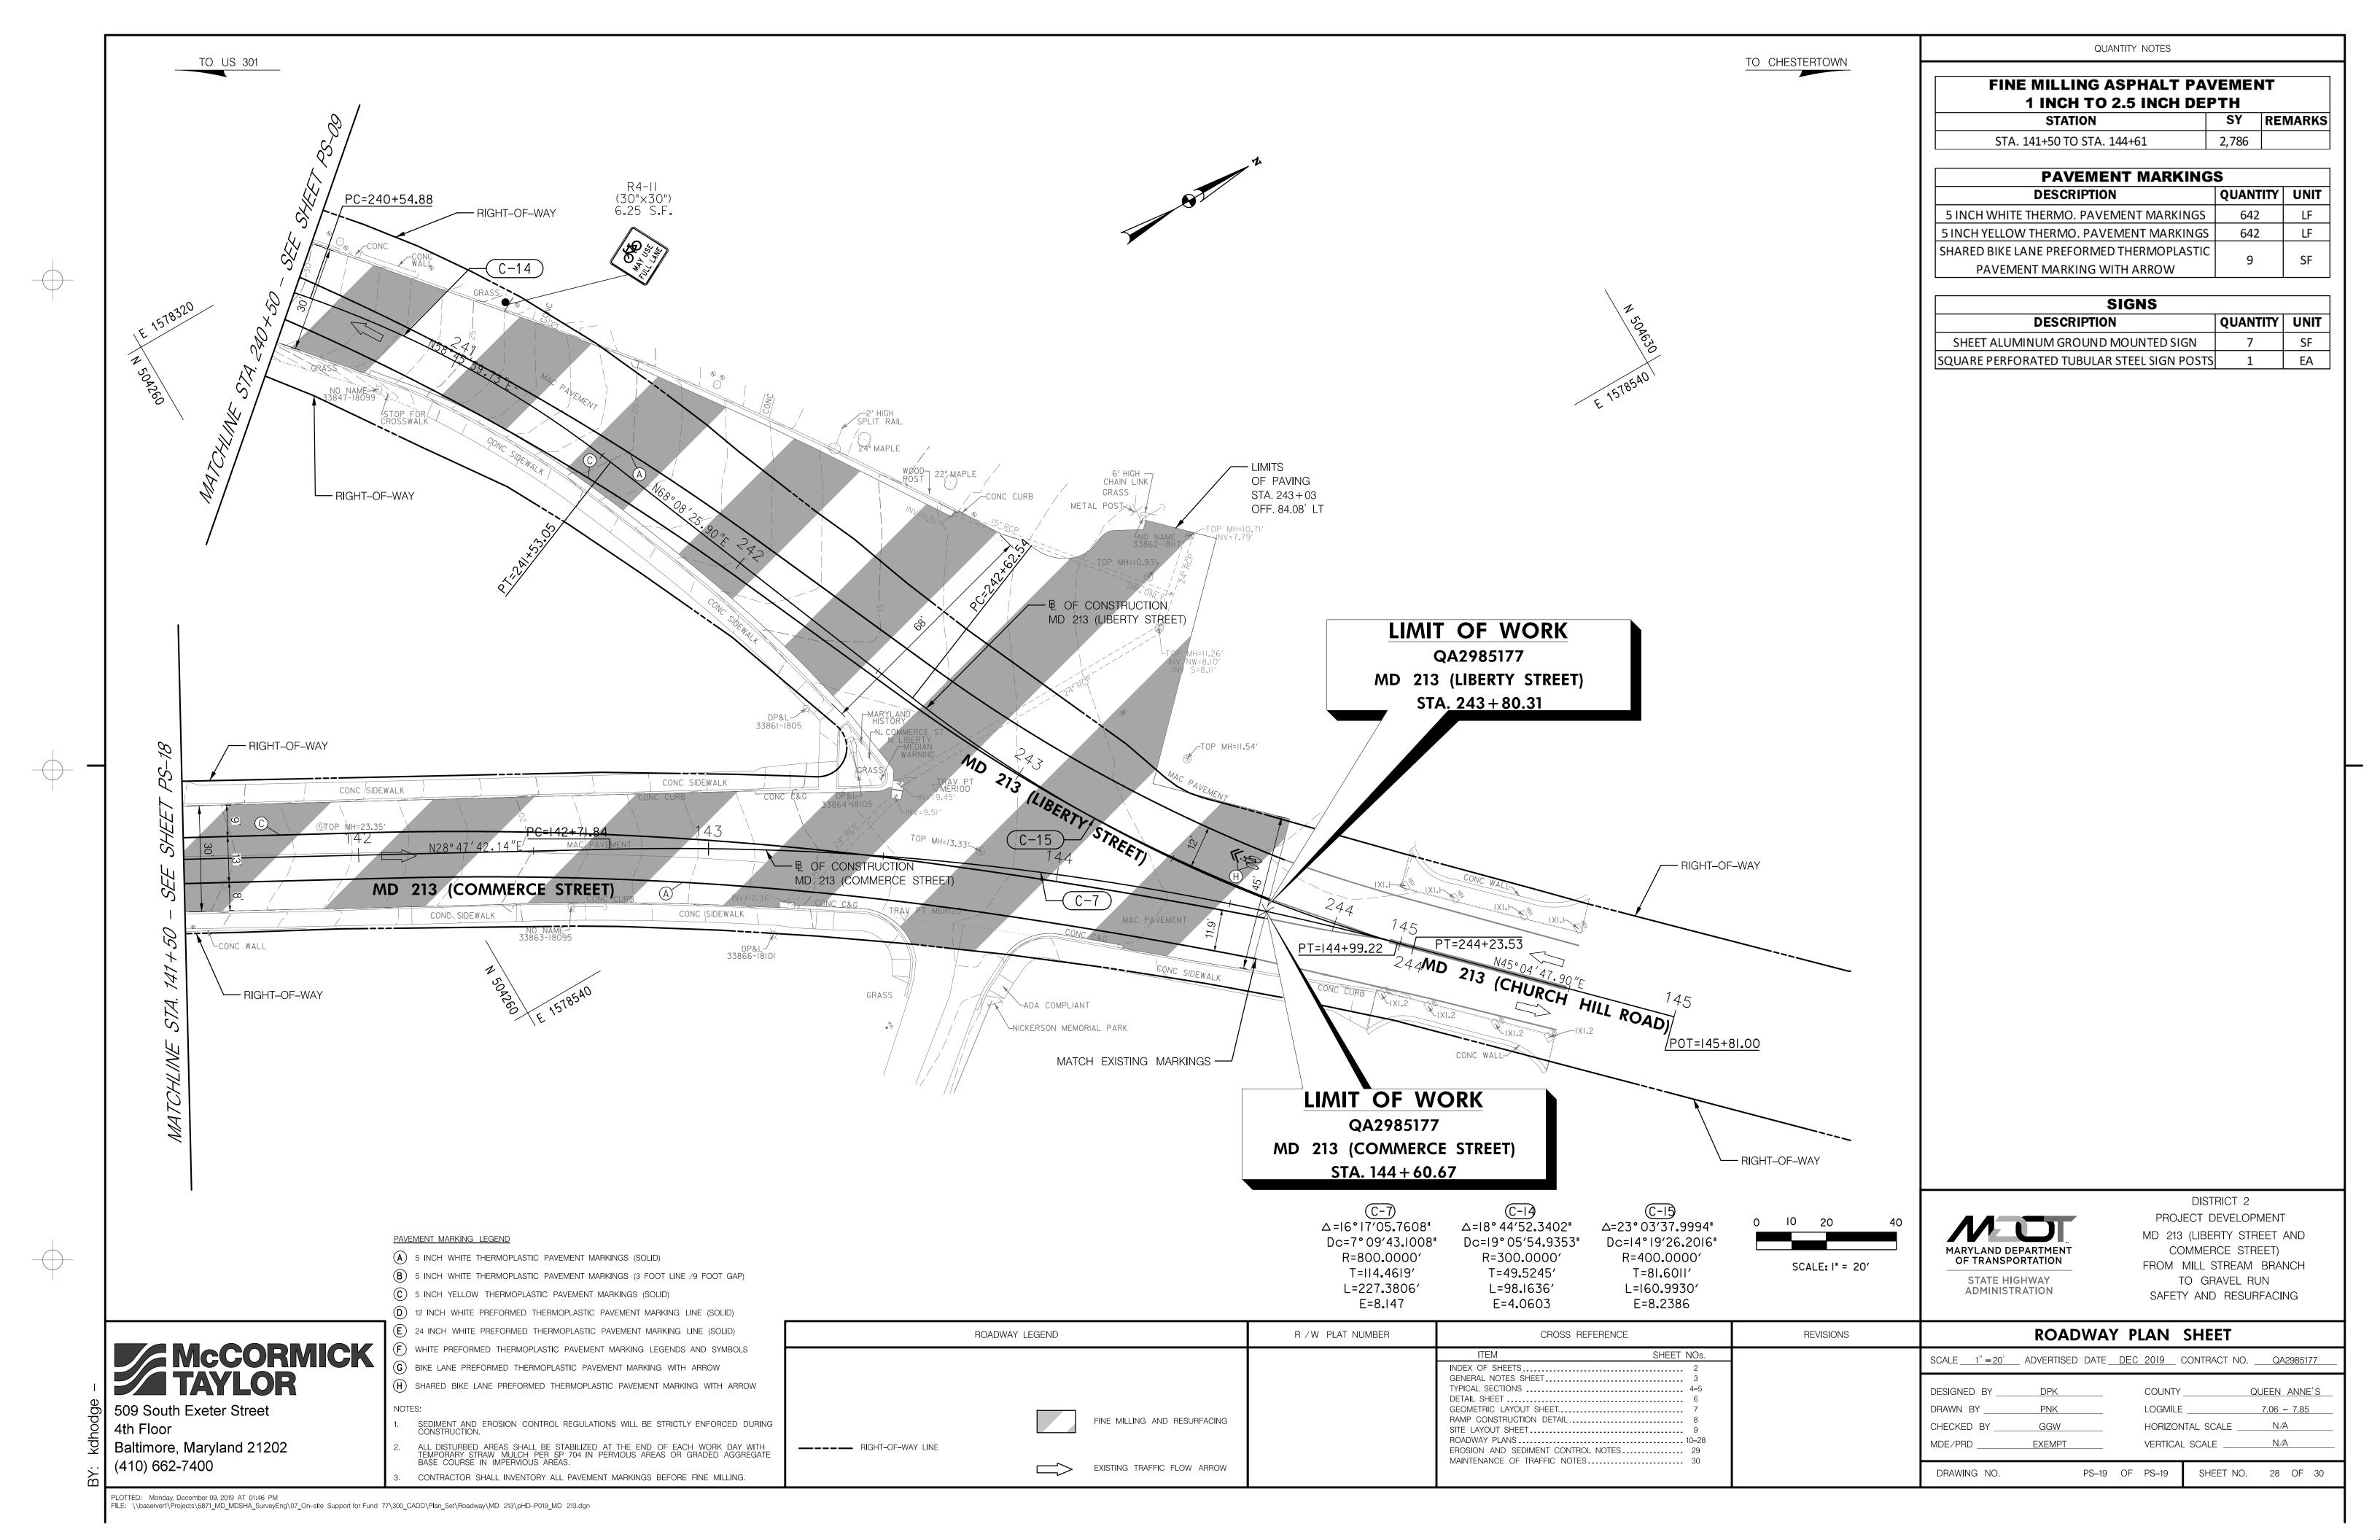

## EROSION AND SEDIMENT CONTROL - GENERAL NOTES

## 1. NOTIFICATION

NOTIFY THE REGIONAL ENVIRONMENTAL COORDINATOR (REC) IN WRITING AND/OR BY TELEPHONE AT (410) 365-0164 PRIOR TO THE FOLLOWING POINTS:

- PRE-CONSTRUCTION MEETING.
- EROSION AND SEDIMENT CONTROL (ESC) MEETING (MINIMUM 7 WORKING DAYS PRIOR TO COMMENCING EARTH DISTURBING
- ACTIVITIES).
   UPON INSTALLATION OF INITIAL ESC MEASURES.
- INSTALLATION OF MAJOR ESC BASINS/TRAPS.
- REMOVAL OR MODIFICATION OF ANY ESC MEASURES.
   REMOVAL OF ALL ESC DEVICES.
- FINAL ACCEPTANCE BY THE ADMINISTRATION.

## 2. STANDARDS AND SPECIFICATIONS

CONSTRUCT THIS PLAN ACCORDING TO THE MARYLAND DEPARTMENT OF THE ENVIRONMENT (MDE) "2011 MARYLAND STANDARDS AND SPECIFICATIONS FOR SOIL EROSION AND SEDIMENT CONTROL", THE MDE "2000 MARYLAND STORMWATER DESIGN MANUAL, VOLUMES I & II", THE MDOT SHA "FIELD GUIDE FOR EROSION AND SEDIMENT CONTROL", THE ANNOTATED CODE OF MARYLAND, THE CODE OF MARYLAND (COMAR) 26.17.01 AND 26.17.02, ALL REVISIONS THERE OF, AND AS SPECIFIED. KEEP A COPY OF THE 2011 "MARYLAND STANDARDS AND SPECIFICATIONS FOR SOIL EROSION AND SEDIMENT CONTROL" ON THE SITE AT ALL TIMES. PERFORM VEGETATIVE STABILIZATION ACCORDING TO THOSE STANDARDS AND AS SPECIFIED.

## 3. INSPECTION

DAILY INSPECT ALL ESC MEASURES AND MAINTAIN THEM IN A CONTINUOUSLY-EFFECTIVE OPERATING CONDITION UNTIL REMOVED AS APPROVED BY THE REC AND THE ENGINEER.

## 4. SHUTDOWNS / LIQUIDATED DAMAGES

COMPLETE COMPLIANCE WITH THE APPROVED ESC PLAN IS EXPECTED AT ALL TIMES. IN CASES WHERE THE CONTRACTOR IS FOUND TO BE IN NON-COMPLIANCE, THE ADMINISTRATION WILL TAKE STEPS TO IMPOSE SELECTED OR TOTAL SHUTDOWNS AND MAY IMPOSE LIQUIDATED DAMAGES FOR NON-COMPLIANCE.

THE ADMINISTRATION'S DISTRICT ENGINEER MAY IMPOSE A TOTAL OR PARTIAL SHUTDOWN IF THE PROJECT MAY ADVERSELY IMPACT THE WATERS OF THE STATE.

## 5. RECORD KEEPING

ENSURE THE STORMWATER MANAGEMENT (SWM)/ESC APPROVAL LETTER, APPROVED EROSION AND SEDIMENT CONTROL PLANS, APPROVED MODIFICATIONS, MODIFICATION APPROVAL LETTER(S), DAILY LOG BOOKS, TEST REPORTS, AND NATIONAL POLLUTANT DISCHARGE ELIMINATION SYSTEM (NPDES) NOTICE OF INTENT (NOI) PERMIT ARE AVAILABLE ON-SITE FOR REVIEW AND INSPECTION BY THE ADMINISTRATION.

## 6. CLEARING AND GRUBBING

UNLESS OTHERWISE SPECIFIED OR APPROVED, LIMIT THE CLEARING AND GRUBBING AREA TO A SINGLE 20-ACRE GRADING UNIT PER GRADING OPERATION. ONCE THIS FIRST UNIT IS HALF GRADED, STABILIZATION MEASURES ARE IN PLACE, AND APPROVED, WORK MAY PROCEED TO A SECOND 20-ACRE GRADING UNIT. UNLESS SPECIFICALLY APPROVED, NO MORE THAN 30 ACRES MAY BE DISTURBED AT ANY TIME.

## 7. SENSITIVE AREAS

WITH THE APPROVAL AND ASSISTANCE OF THE ENGINEER, COORDINATE WITH THE APPROPRIATE ADMINISTRATION REPRESENTATIVES TO COORDINATE WITH THE APPROPRIATE REGULATORY AGENCIES TO ENSURE THAT ALL PERMIT CONDITIONS ARE MET PRIOR TO COMMENCING CONSTRUCTION ACTIVITIES WITHIN SPECIFIED SENSITIVE AREAS. SENSITIVE AREAS INCLUDE BUT ARE NOT LIMITED TO FLOODPLAINS, WETLANDS, WETLAND BUFFERS, CHESAPEAKE BAY CRITICAL AREA, FORESTS, ARCHEOLOGICAL SITES, HISTORIC SITES, PARKLAND, AND OPEN WATERS. DESIGNATE A RESPONSIBLE PARTY TO MONITOR ALL WORK IN THESE AREAS AND ENSURE THAT REASONABLE CARE IS TAKEN DURING WORK IN AND ADJACENT TO THESE AREAS.

## 8. INGRESS / EGRESS CONTROLS

PROTECT ALL POINTS OF CONSTRUCTION INGRESS AND EGRESS AND PREVENT THE DEPOSITION OF MATERIALS ON PUBLIC ROADS. IF DEPOSITION OCCURS, MECHANICALLY REMOVE ALL MATERIALS DEPOSITED ON PUBLIC ROADS IMMEDIATELY. FLUSHING OF ROAD SURFACES IS PROHIBITED.

# 9. EROSION AND SEDIMENT CONTROL EXCAVATION

DISPOSE OF MATERIAL REMOVED FROM ESC DEVICES IN AN APPROVED WASTE SITE AS SPECIFIED IN SECTION 201. MATERIALS MAY BE STORED FOR RE-USE. MATERIALS STORED ON-SITE MAY BE REUSED ONCE IT IS DRIED AND IF IT MEETS THE REQUIREMENTS FOR EMBANKMENTS OR OTHER UNSPECIFIED NEEDS.

## 10. DEWATERING PRACTICES

OPERATE DEWATERING PRACTICES IN A MANNER THAT DOES NOT DISCHARGE SEDIMENT INTO WATERWAYS. NO VISIBLE CHANGES TO STREAM CLARITY ARE ACCEPTABLE.

## 11. STANDARD STABILIZATION NOTE

FOLLOWING INITIAL SOIL DISTURBANCE OR REDISTURBANCE, COMPLETE PERMANENT OR TEMPORARY STABILIZATION WITHIN THREE (3) CALENDAR DAYS FOR SURFACES OF ALL PERIMETER CONTROLS, DIKES, SWALES, DITCHES, PERIMETER SLOPES, AND ALL SLOPES GREATER THAN 3 HORIZONTAL TO 1 VERTICAL (3:1); AND SEVEN (7) DAYS AS TO ALL OTHER DISTURBED OR GRADED AREAS ON THE SITE. ENSURE CONTINUED STABILIZATION.

## 12. INCREMENTAL STABILIZATION

REFER TO THE MDE "2011 MARYLAND STANDARDS AND SPECIFICATIONS FOR SOIL EROSION AND SEDIMENT CONTROL" FOR THE INCREMENTAL STABILIZATION OF CUT AND FILLS.

## 13. SEDIMENT TRAPS AND BASINS

PLAN DIMENSIONS ARE RELATIVE TO THE OUTLET ELEVATION.
MAINTAIN INFLOW AND OUTFLOW LOCATIONS FOR TRAPS AND BASINS
IN STABLE CONDITION.

## 14. OFF-SITE UTILITY WORK

FOLLOW ADDITIONAL BEST MANAGEMENT ESC PRACTICES FOR UTILITY CONSTRUCTION IN AREAS OUTSIDE OF DESIGNED CONTROLS:

- (a) CALL "MISS UTILITY" AT 1-800-257-7777 AT LEAST 48 HOURS PRIOR TO THE START OF WORK.
- (b) PLACE EXCAVATED MATERIAL ON THE HIGH SIDE OF TRENCHES.(c) BACKFILL, COMPACT, AND STABILIZE AT THE END OF EACH WORKING DAY ALL TRENCHES FOR UTILITY
- INSTALLATIONS. WHEN THIS IS NOT POSSIBLE, CONFORM TO (d).
  (d) PLACE TEMPORARY SILT FENCES IMMEDIATELY DOWNSTREAM
  OF ANY DISTURBED AREA THAT IS INTENDED TO REMAIN
  DISTURBED FOR MORE THAN ONE (1) DAY.

## 15. SITE INFORMATION\*

A. TOTAL AREA DISTURBED B. TOTAL CUT C. TOTAL FILL	0.11 5 5	ACRES CU. YDS CU. YDS
D. OFFSITE WASTE/BORROW AREA LOCATION (IF KNOWN)	TBD	

\* (NOT FOR BIDDING PURPOSES)

## 16. MODIFICATIONS

SUBMIT MODIFICATIONS OF THE ESC MEASURES OR PLAN TO THE ADMINISTRATION FOR APPROVAL. OBTAIN ALL APPROVALS PRIOR TO IMPLEMENTING ANY MODIFICATION.

STANDARD SYMBOLS								
AT-GRADE INLET PROTECTION	AGIP	PERMANENT SOIL STABILIZATION MATTING-TYPE B	B B B	TEMPORARY ACCESS BRIDGE	ТВ			
BAFFLE BOARDS		PERMANENT SOIL STABILIZATION MATTING-TYPE C		TEMPORARY ACCESS CULVERT				
BENCHING	BENCHING	PIPE OUTLET SEDIMENT TRAP ST I	ST-I	TEMPORARY ASPHALT BERM	T <u>AB</u>			
CATCH BASIN INSERT	СВІ	PIPE SLOPE DRAIN  NOTE: DESIGNATION PSD-12  REFERS TO PIPE SLOPE  DRAIN WITH 12 IN PIPE	PSD - 12	TEMPORARY BARRIER DIVERSION	TBD			
CLEAR WATER DIVERSION PIPE NOTE: DESIGNATION CWD-12 REFERS TO CLEAR WATER DIVERSION WITH 12 INCH PIPE.	CWD - 12	PLUNGE POOL	PP	TEMPORARY GABION OUTLET STRUCTURE	TGOS			
CLEAR WATER PIPE	⊢∏  CWP	PORTABLE SEDIMENT TANK	⊠PST	TEMPORARY SOIL STABILIZATION MATTING-TYPE A				
COMBINATION INLET PROTECTION	COIP	REMOVABLE PUMPING STATION	⊠RPS	TEMPORARY SOIL STABILIZATION MATTING-TYPE E				
CONCRETE WASHOUT STRUCTURE	CWS	RIPRAP INFLOW PROTECTION	[ RRP	TEMPORARY SOIL STABILIZATION MATTING-TYPE D				
CURB INLET PROTECTION	[ <del>-</del> ]cn	RIPRAP OUTLET SEDIMENT TRAP ST III	ST-III	TEMPORARY STONE OUTLET STRUCTURE	<b>≪</b> ₩ TSOS			
DIVERSION FENCE	├── DF ───┤	ROCK OUTLET PROTECTION I	ROPI	TEMPORARY SWALE  NOTE: PLACE DESIGNATION (A-1, B-2, ETC.) ON FLOW CHANNEL SIDE OF SWALE.	<b>→</b> A-1			
EARTH DIKE  NOTE: PLACE DESIGNATION (A-1, B-2, ETC.) ON FLOW CHANNEL SIDE OF DIKE.	<b>▲</b> -I	ROCK OUTLET PROTECTION II	ROPII	VERTICAL DRAW-DOWN DEVICE	VDDD			
EMERGENCY SPILLWAY	ES	ROCK OUTLET PROTECTION III	ROPIII	WASH RACK OPTION	WR			
FILTER BAG	⊠ғв	SILT FENCE	SF	CHESAPEAKE BAY CRITICAL AREA	—— СВСА ——			
FILTER BERM	IFB-AI IFB-BI	SILT FENCE ON PAVEMENT	SF0P	DRAINAGE BOUNDARY	DA			
FILTER LOG  NOTE: DESIGNATION FL-18 REFERS TO FILTER LOG WITH 18 INCH DIAMETER.	FL-18	SOD	* * * * * * * * * * * * * * * * * * * *	EXISTING CONTOURS				
GABION INFLOW PROTECTION	GP G	STABILIZED CONSTRUCTION ENTRANCE (SCE)	SCE SCE	LIMIT OF DISTURBANCE (LOD)	—— LOD ——			
GABION INLET PROTECTION	GIP	STANDARD INLET PROTECTION	SIP	PROPOSED CONTOURS	—— 100 ——			
HORIZONTAL DRAW-DOWN DEVICE	HDDD	STOCKPILE AREA		TEMPORARY ORANGE CONSTRUCTION FENCE (TOCF)				
LIMIT OF DISTURBANCE	——LOD——	STONE CHECK DAM	CD	TREE PROTECTION FENCE	—— TPF ——			
MEDIAN INLET PROTECTION	MIP	STONE/RIPRAP OUTLET SEDIMENT TRAP ST II	ST-II	WETLAND	• • • • •			
MEDIAN SUMP INLET PROTECTION	MSIP	SUBSURFACE DRAINS	├─ SSD ── ┤	WETLAND BUFFER	— в —			
MOUNTABLE BERM	MB	SUMP PIT	⊠SP	100-YEAR FLOODPLAIN	<del></del>			
PERIMETER DIKE/SWALE	₽DS-I € € €	SUPER SILT FENCE	├──SSF──I					
					<del></del>			

## SEQUENCE OF CONSTRUCTION

THE CONTRACTOR SHALL NOTIFY THE SHA REGIONAL ENVIRONMENTAL COORDINATOR (REC) AT (410) 365-0164, SEVEN (7) DAYS BEFORE ANY LAND DISTURBANCE ACTIVITY AND HOLD A PRE-CONSTRUCTION MEETING BETWEEN PROJECT REPRESENTATIVES AND REPRESENTATIVES OF SHA.

ESTABLISH THE LOD.

- 2. WITH WRITTEN APPROVAL FROM SHA REC COMMENCE WORK AS INDICATED ON THE PLANS.
  3. CONSTRUCT PEDESTRAIN CURB RAMPS AND OTHER ROADWAY IMPROVEMENTS.
- 4. ALL DISTURBED AREAS SHALL BE STABILIZED AT THE END OF EACH WORK DAY.
- 5. COMPLETE PAVEMENT OVERLAY AND PAVEMENT MARKINGS. STABILIZE ANY DISTURBANCE AT THE END OF EACH WORK DAY.

MARYLAND DEPARTMENT
OF TRANSPORTATION

STATE HIGHWAY
ADMINISTRATION

**REVISIONS** 

DISTRICT 2
PROJECT DEVELOPMENT

1D 213 (CENTREVILLE ROA

MD 213 (CENTREVILLE ROAD)
FROM MILL STREAM BRANCH
TO GRAVEL RUN
SAFETY AND RESURFACING



P.E. CERTIFICATION

I HEREBY CERTIFY THAT THESE
DOCUMENTS WERE PREPARED
OR APPROVED BY ME, AND
THAT I AM A DULY LICENSED
PROFESSIONAL ENGINEER
UNDER THE LAWS OF
THE STATE OF MARYLAND

LICENSE NO. 38630

EXPIRATION DATE: 4/8/2020

DESIGN CERTIFICATION

I HEREBY CERTIFY THAT THIS PLAN HAS BEEN DESIGNED IN ACCORDANCE WITH THE MARYLAND STANDARDS AND SPECIFICATIONS FOR SOIL EROSION AND SEDIMENT CONTROL, THE 2000 MARYLAND STORMWATER DESIGN MANUAL, VOLUMES 1 & II INCLUDING SUPPLEMENTS, THE ENVIRONMENT ARTICLE SECTIONS 4–101 THROUGH 116 AND SECTIONS 4–201 AND 215, AND THE CODE OF MARYLAND REGULATIONS (COMAR) 26.17.01 AND COMAR 26.17.02 FOR EROSION AND SEDIMENT CONTROL AND STORMWATER MANAGEMENT, RESPECTIVELY.

EROSION AND SEDIMENT CONTROL NOTES SCALE NTS ADVERTISED DATE DEC 2019 CONTRACT NO. QA2985177 DESIGNED BY COUNTY QUEEN ANNE'S LOGMILE 7.06 - 7.85JND HORIZONTAL SCALE \_ N/A CHECKED BY MDE/PRD 16-PR-0129 VERTICAL SCALE N/A DRAWING NO. EN - 01 OF 01 SHEET NO. 29 OF 30

#### SEQUENCE OF CONTRUCTION

- I. INSTALL EROSION AND SEDIMENT CONTROL MEASURES.
- 2. INSTALL TEMPORARY TRAFFIC CONTROL DEVICES PER THE APPROPRIATE TTCTA.
- 3. CONSTRUCT PEDESTRIAN CURB RAMPS AND OTHER ROADWAY IMPROVMENTS.
- 4. COMPLETE FINAL SUPERPAVE OVERLAY.
- 5. INSTALL FINAL PAVEMENT MARKINGS.

I. ALL MAINTENANCE OF TRAFFIC ACTIVITIES SHALL ADHERE TO THE MARYLAND DEPARTMENT OF TRANSPORTATION'S STATE HIGHWAY ADMINISTRATION'S "BOOK OF STANDARDS FOR HIGHWAYS AND INCIDENTAL STRUCTURES." ALL TEMPORARY SIGNING, PAVEMENT MARKINGS, CHANNELIZING DEVICES, AND OTHER ITEMS USED FOR MAINTENANCE OF TRAFFIC SHALL CONFORM TO THE LATEST MARYLAND DEPARTMENT OF TRANSPORTATION STATE HIGHWAY ADMINISTRATION STANDARDS.

- 2. UNLESS OTHERWISE NOTED OR DIRECTED BY THE ENGINEER, TEMPORARY TRAFFIC CONTROL SIGNS SHALL REMAIN IN PLACE THROUGHOUT THE DURATION OF CONSTRUCTION. SIGNS SHOULD BE MOUNTED ON BREAKAWAY POSTS AND HAVE RETROREFLECTIVE SHEETING AS PER THE CONTRACT SPECIFICATIONS.
- 3. LONGITUDINAL DISTANCES OF ALL ADVANCED WARNING SIGNS AND CHANNELIZING DEVICES MAY BE ADJUSTED DUE TO INTERSECTING STREETS, DRIVEWAYS, AND/OR FIELD CONDITIONS AS APPROVED BY THE ENGINEER. WHERE ADVANCE SIGNING CONFLICTS WITH TEMPORARY SIGNING FOR LANE CLOSURE, LANE SHIFT OR FLAGGING OPERATION, ADJUSTMENTS TO ADVANCE SIGNING SHALL BE MADE PER THE ENGINEER TO AVOID CONFUSING AND/OR CONFLICTING MESSAGES.
- 4. REFER TO THE CONTRACT SPECIAL PROVISIONS (SECTION 104.01) FOR APPLICABLE WORKING HOURS AND LANE CLOSURE RESTRICTIONS.
- ADDITIONAL LANE CLOSURES FOR PLACEMENT OF TRAFFIC CONTROL DEVICES, DELIVERY OF MATERIAL, ETC., MUST BE APPROVED BY AND SCHEDULED IN WRITING WITH THE ENGINEER AND SHALL BE IN ACCORDANCE WITH SHA'S BOOK OF STANDARDS.

#### MAINTENANCE OF TRAFFIC GENERAL NOTES

6. CHANNELIZING DEVICES SHALL BE USED TO DEFINE THE EDGE OF THE TRAVEL LANE AT LOCATIONS WHERE NEW CONSTRUCTION HAS CREATED A CURB LANE WITH A WIDTH GREATER THAN 13 FEET. FOLLOWING INSTALLATION OF THE SURFACE COURSE, TEMPORARY AND FINAL PAVEMENT MARKINGS SHALL BE INSTALLED PER THE EXISTING CONFIGURATION.

MAINTENANCE OF TRAFFIC GENERAL NOTES (CONTINUED)

- 7. CONFLICTING, INAPPROPRIATE, OR NOT APPLICABLE SIGNS (INCLUDING WORK ZONE SIGNS) SHALL BE REMOVED, COVERED, OR FOLDED TO PREVAILING CONDITIONS SO THAT THEY ARE NOT READABLE BY ONCOMING TRAFFIC. AT THE CONCLUSION OF WORK, SIGNS REMOVED, MODIFIED, OR DAMAGED DURING CONSTRUCTION OPERATIONS SHALL BE REINSTALLED OR REPLACED AT THE CONTRACTORS EXPENSE, AS INDICATED OR DIRECTED BY THE ENGINEER.
- 8. A MINIMUM SPACING OF 200 FEET SHALL BE MAINTAINED BETWEEN ALL REGULATORY, WARNING, AND DESTINATION SIGNS.
- 9. THESE NOTES AND SPECIFICATIONS ARE THE MINIMUM REQUIREMENTS FOR THE CONDITIONS SET FORTH. THE ENGINEER MAY REQUIRE ADDITIONAL TRAFFIC CONTROL DEVICES AND MAY ALTER THE SEQUENCE OF CONSTRUCTION OR MEANS OF TRAFFIC CONTROL AS NECESSARY.
- IO. ALL EXCAVATIONS SHALL BE PAVED TO THE LEVEL OF THE ADJACENT PAVEMENT AT THE END OF THE WORK DAY. EXCAVATIONS REMAINING AT THE END OF WORKING HOURS SHALL, AT A MINIMUM, BE BACKFILLED PER MD 104.01-28.

MAINTENANCE OF TRAFFIC NOTES..

#### TEMPORARY TRAFFIC CONTROL TYPICAL APPLICATIONS (TTCTA)

THE FOLLOWING TICTA FROM THE MDOT SHA "BOOK OF STANDARDS FOR HIGHWAYS AND INCIDENTAL STRUCTURES PROVIDE GUIDANCE FOR TYPICAL MAINTENANCE OF TRAFFIC APPLICATIONS AS THEY RELATE TO MD 140. MODIFICATION OF THESE TTCTA SHALL BE APPROVED BY THE ENGINEER.

- MD 104.02-02 -SHOULDER WORK
- MD 104.02-04 LANE SHIFT
- MD 104.02-10 FLAGGING OPERATION
- MD 104.02-14 INTERSECTION FLAGGING OPERATION
- MD 104.06-09A PED AND CURB-LANE CONTROL
- MD 104.06-09C PED AND CURB-LANE CONTROL
- MD 104.06-16 PAVEMENT EDGE DROP-OFF 2.5 INCHES OR LESS (BETWEEN TRAFFIC LANES AND SHOULDER)
- MD 104.06-17 PAVEMENT EDGE DROP-OFF GREATER THAN 2.5 INCHES
  - BUT EQUAL TO OR LESS THAN 5 INCHES (BETWEEN TRAFFIC LANES AND SHOULDER)

MARYLAND DEPARTMENT OF TRANSPORTATION STATE HIGHWAY **ADMINISTRATION** 

DRAWING NO.

DISTRICT 2 PROJECT DEVELOPMENT MD 213 (LIBERTY STREET AND COMMERCE STREET) FROM MILL STREAM BRANCH TO GRAVEL RUN SAFETY AND RESURFACING

SHEET NO. 30 OF 30

MT-01 OF MT-01

MAINTENANCE OF TRAFFIC GENERAL NOTES R / W PLAT NUMBER CROSS REFERENCE REVISIONS ITEM SHEET NOs. SCALE N.T.S. ADVERTISED DATE DEC 2019 CONTRACT NO. QA2985177 INDEX OF SHEETS .. GENERAL NOTES SHEET. TYPICAL SECTIONS . DESIGNED BY COUNTY QUEEN ANNE'S DETAIL SHEET. GEOMETRIC LAYOUT SHEET. DRAWN BY LOGMILE 7.06 - 7.85 RAMP CONSTRUCTION DETAIL. GGW HORIZONTAL SCALE \_ CHECKED BY SITE LAYOUT SHEET .. ROADWAY PLANS. MDE/PRD \_ EXEMPT VERTICAL SCALE EROSION AND SEDIMENT CONTROL NOTES.



509 South Exeter Street 4th Floor Baltimore, Maryland 21202 (410) 662-7400